

NOTE: SHADOWS ARE SIMILAR TO (E) 2-STORY HOUSE THAT IS BEING REPLACED

_	SOLAR SHADOW TABLE				
	DATE	TIME	ALTITUDE	AZIMUTH	
	DEC 21	9 AM	14	42	
	DEC 21	3 PM	14	42	
	MAR 21	9 AM	34	58	
	MAR 21	3 PM	34	58	
	JUN 21	9 AM	47	77	
	JUN 21	3 PM	47	77	
			•		

SOLAR SHADOW STUDY

FIRE DEPARTMENT NOTES

MARZI SAN

SUN 21 9 AM

WILDLAND-URBAN INTERFACE: THIS PROJECT IS LOCATED WITHIN THE DESIGNATED WILDLAND-URBAN INTERFACE FIRE AREA. THE BUILDING CONSTRUCTION SHALL COMPLY WITH THE PROVISIONS OF ADDRESS IDENTIFICATION: CALIFORNIA BUILDING CODE (CBC) CHAPTER 7A. NOTE THAT NEW AND EXISTING BUILDINGS SHALL HAVE APPROVED VEGETATION CLEARANCE SHALL BE IN COMPLIANCE WITH CBC SECTION 70 | A.3.2.4 PRIOR TO PROJECT FINAL

FIRE SPRINKLERS REQUIRED:

PLANS, CALCULATIONS, A

RELATED LANDSCAPE PLAN REQUIREMENTS.

AN AUTOMATIC SPRINKLER SYSTEM SHALL BE INSTALLED IN NUMBERS SHALL BE A MINIMUM OF 4 INCHES (101.6mm) ONE- AND TWO-FAMILY DWELLINGS AS FOLLOWS: IN ALL NEW ONE- AND TWO-FAMILY DWELLINGS AND IN EXISTING ONE- AND TWO-FAMILY DWELLINGS WHEN ADDITIONS ARE AND THE BUILDING CANNOT BE VIEWED FROM THE PUBLIC MADE THAT INCREASE THE BUILDING AREA TO MORE THAN WAY, A MONUMENT, POLE OR OTHER SIGN OR MEANS 3,600 SQUARE FEET. EXCEPTION: ANY ONE-TIME ADDITION TO AN EXISTING

BUILDING THAT DOES NOT TOTAL MORE T HAN 1,000 SQUARE FEET OF BUILDING AREA. NOTE: THE OWNER(S), OCCUPANT(S) AND ANY CONTRACTOR(S) OR SUBCONTRACTOR(S) ARE RESPONSIBLE FOR CONSULTING WITH THE WATER PURVEYOR OF RECORD IN ORDER TO DETERMINE IF ANY MODIFICATION OR UPGRADE OF THE EXISTING WATER SERVICE IS REQUIRED. NOTE: COVERED PORCHES, PATIOS, THE PURVEYOR. SUCH REQUIREMENTS SHALL BE BALCONIES, AND ATTIC SPACES MAY REQUIRE FIRE

THIS DEPARTMENT FOR REVIEW AN APPROVAL PRIOR TO BEGINNING THEIR WORK.

(C-16) FIRE PROTECTION CONTRACTOR SHALL SUBMIT

CONSTRUCTION SITE FIRE SAFETY PROVISIONS OF THE CFC CHAPTER 33 AND OUR STANDARD THAT PURVEYOR AS HAVING BEEN MET BY THE DETAIL AND SPECIFICATION SI-7. PROVIDE APPROPRIATE APPLICANT(S).

NOTATIONS ON SUBSEQUENT PLAN SUBMITTALS, AS APPROPRIATE TO THE PROJECT.

l"= 16'-0"

ADDRESS NUMBERS, BUILDING NUMBERS OR APPROVED BUILDING IDENTIFICATION PLACED IN A POSITION THAT IS APPROVAL. CHECK WITH THE PLANNING DEPARTMENT FOR PLAINLY LEGIBLE AND VISIBLE FROM THE STREET OR ROAD FRONTING THE PROPERTY. THESE NUMBERS SHALL CONTRAST WITH THEIR BACKGROUND. ADDRESS NUMBERS SHALL BE ARABIC NUMBERS OR ALPHABETICAL LETTERS. HIGH WITH A MINIMUM STROKE WIDTH OF 0.5 INCH (12.7mm). WHERE ACCESS IS BY MEANS OF PRIVATE ROAD SHALL BE USED TO IDENTIFY THE STRUCTURE.

WATER SUPPLY REQUIREMENT: POTABLE WATER SUPPLIES SHALL BE PROTECTED FROM CONTAMINATION CAUSED BY FIRE PROTECTION WATER SUPPLIES. IT IS THE RESPONSIBILITY OF THE APPLICANT AND ANY CONTRACTORS AND SUBCONTRACTORS TO CONTACT THE WATER PURVEYOR SUPPLYING THE SITE OF SUCH PROJECT, AND TO COMPLY WITH THE REQUIREMENTS OF INCORPORATED INTO THE DESIGN OF ANY WATER-BASED SPRINKLER COVERAGE. A STATE OF CALIFORNIA LICENSED > FIRE PROTECTION SYSTEMS, AND/OR FIRE SUPPRESSION WATER SUPPLY SYSTEMS OR STORAGE CONTAINERS THAT MAY BE PHYSICALLY CONNECTED IN ANY MANNER TO AN COMPLETE PERMIT APPLICATION AND APPROPRIATE FEES TO APPLIANCE CAPABLE OF CAUSING CONTAMINATION OF THE POTABLE WATER SUPPLY OF THE PURVEYOR OF RECORD. FINAL APPROVAL OF THE SYSTEM(S) UNDER CONSIDERATION WILL NOT BE GRANTED BY THE FIRE DEPT.

OFFICE UNTIL COMPLIANCE WITH THE REQUIREMENTS OF ALL CONSTRUCTION SITES MUST COMPLY WITH APPLICABLE(THE WATER PURVEYOR OF RECORD ARE DOCUMENTED BY

TREES TO BE REMOVED			
NO.	SPECIES	DIA (IN.)	
RI	MAPLE	4, 4, 4	
R2	MAPLE	8	
R3(2)	MONTEREY PINE	18	
R4(3)	WESTERN REDBUD	5, 3	
R5(5)	EVERGREEN PEAR	5	
R7(15)	PACIFIC WAX MYRTLE	5	

PROJECT DATA

OWNER: URBAN WEST, LLC

2-STORY HOUSE W/ CELLAR

CONSTRUCTION TYPE: V-B

OCCUPANCY GROUP: R-3/U

AVERAGE LOT SLOPE: 7.7%

 $\{.35 - [(7-5)(.2)/25]\} \times 7,000 = 2,338 \pm SQ. FT.$

1,380

946

2,326

819

244

33.2%

1,380

244

145

105

1,874

1,380

244

145

1,769 = 25.27%

LOT SIZE: 7,000 SQ. FT.

PROPOSED FLOOR AREA

PROPOSED F.A.R.

IMPERVIOUS COVERAGE CALC

LIGHTWELL & LANDING

ALLOWABLE FAR:

IST FLOOR

TOTAL

CELLAR

GARAGE

HOUSE

GARAGE

PORCH

TOTAL

LIVING AREA

GARAGE

BUILDING COVERAGE

COVERED PORCH

VICINITY MAP

2ND FLOOR

HOUSE TO BE FULLY FIRE-SPRINKLED

PROJECT DESCRIPTION:

APN: 510-40-146


ZONING: R-1-8

PROJECT ADDRESS: 18151 OVERLOOK ROAD, LOS GATOS, CA

DEMOLISH (E) 2-STORY HOUSE + (E) DETACHED GARAGE AND BUILD NEW

*REMOVE BY PERMIT #7 | 5-053

SPECIES	
	DIA (IN.)
DEODAR CEDAR	22
EUROPEAN BEECH	16
COAST LIVE OAK	23
COAST LIVE OAK	17
MONTEREY PINE	15
GLOSSY PRIVIT	11
GLOSSY PRIVIT	9
MONTEREY PINE	36
GLOSSY PRIVIT	8, 6, 5, 4
COAST LIVE OAK	35
	EUROPEAN BEECH COAST LIVE OAK COAST LIVE OAK MONTEREY PINE GLOSSY PRIVIT MONTEREY PINE GLOSSY PRIVIT

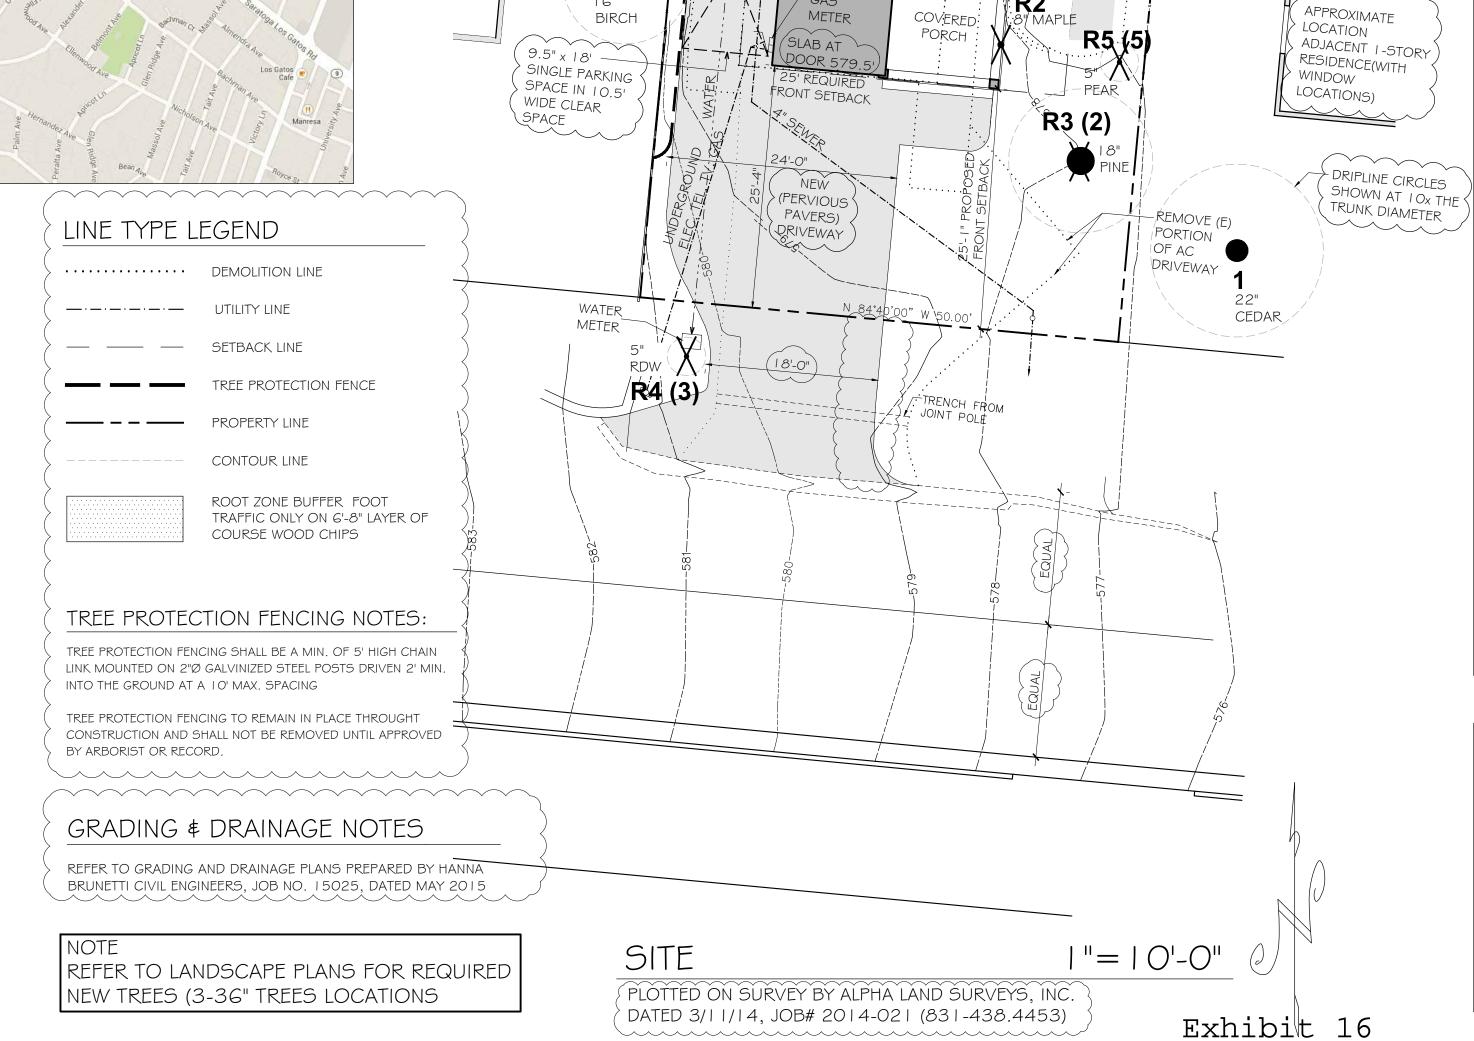

DRAWINGS PREPARED BY

PRIVET

PRIVET

TINSTALL TREE PROTECTION FENCING

OAK

,- ROOT ZONE BUFFER

-PROPOSED 2ND

PERIMETER LINE

OAK

NEW 2ND STORY

_6'-0" FENCE

WINDOW

WIGATE

LOCATIONS

8'-1" PROPOSED

STORY EXTERIOR

OAK.

PER

PROTECTION

OUTLINE OF BASEMENT

PROPOSED (N)

2-STORY HOUSE

(RELOCATE TO CENTER ON LOT)

IST FLR FF ELEV. 580.0'

2ND FLR FF ELEV. 590.61

CELLAR T.O.S. ELEV. 569.39'

TRIPLE 4" MAPLE

HOUSE AND

(E) DETACHED

GARAGE

-GARAGE-

-GAS

PERMIT

MULTI-

(N) 6' TALL REDWOOD FENCE

ON SIDE AND REAR PROPERTY

APPROXIMATE LOCATION

RESIDENCE(WITH WINDOW

EXISTING HOUSE FLOOR AREA

DETACHED GARAGE

EXISTING MPERVIOUS COVERAGE CALC

823

823

1,646

422

823

422

684

966

2,895

1,245 = 17.8%

__COVERED

PORCH⁻

IST FLOOR

2ND FLOOR

TOTAL

HOUSE

GARAGE

DRIVEWAY

CONC WALK

TOTAL (E)

BUILDING COVERAGE

ADJACENT 1-STORY

LOCATIONS)

8'-1" PROPOSED

LEFT-SIDE SETBACK

6'-0" FENCE

W/GATE

LINES - SIDE FENCES TO BEGIN 25' FROM FRONT

PRIVET

9 MYRTLE

(ALREADY

REMOVED

T15-053)

20' REQUIRED REAR SETBACK

CHRIS SPAULDING \Box A R C H I T E C T \Box

801 CAMELIA STREET SUITE E BERKELEY CALIFORNIA 94710 (510) 527-5997 FAX (510) 527-5999


REVISIONS BY9-22-14 6-25-15 9-24-15 12-8-15 12-22-15 1-26-16

-		
	PRELIMINARY SET	
	DESIGN REVIEW SET	
	PLAN CHECK SET	
	PERMIT SET	
	CONSTRUCTION SET	

IFOR

DATE: 6-10-14 SCALE: AS NOTED DRAWN: EL/CS/DB/KD TATE - OVERLOOK JOB: SHEET



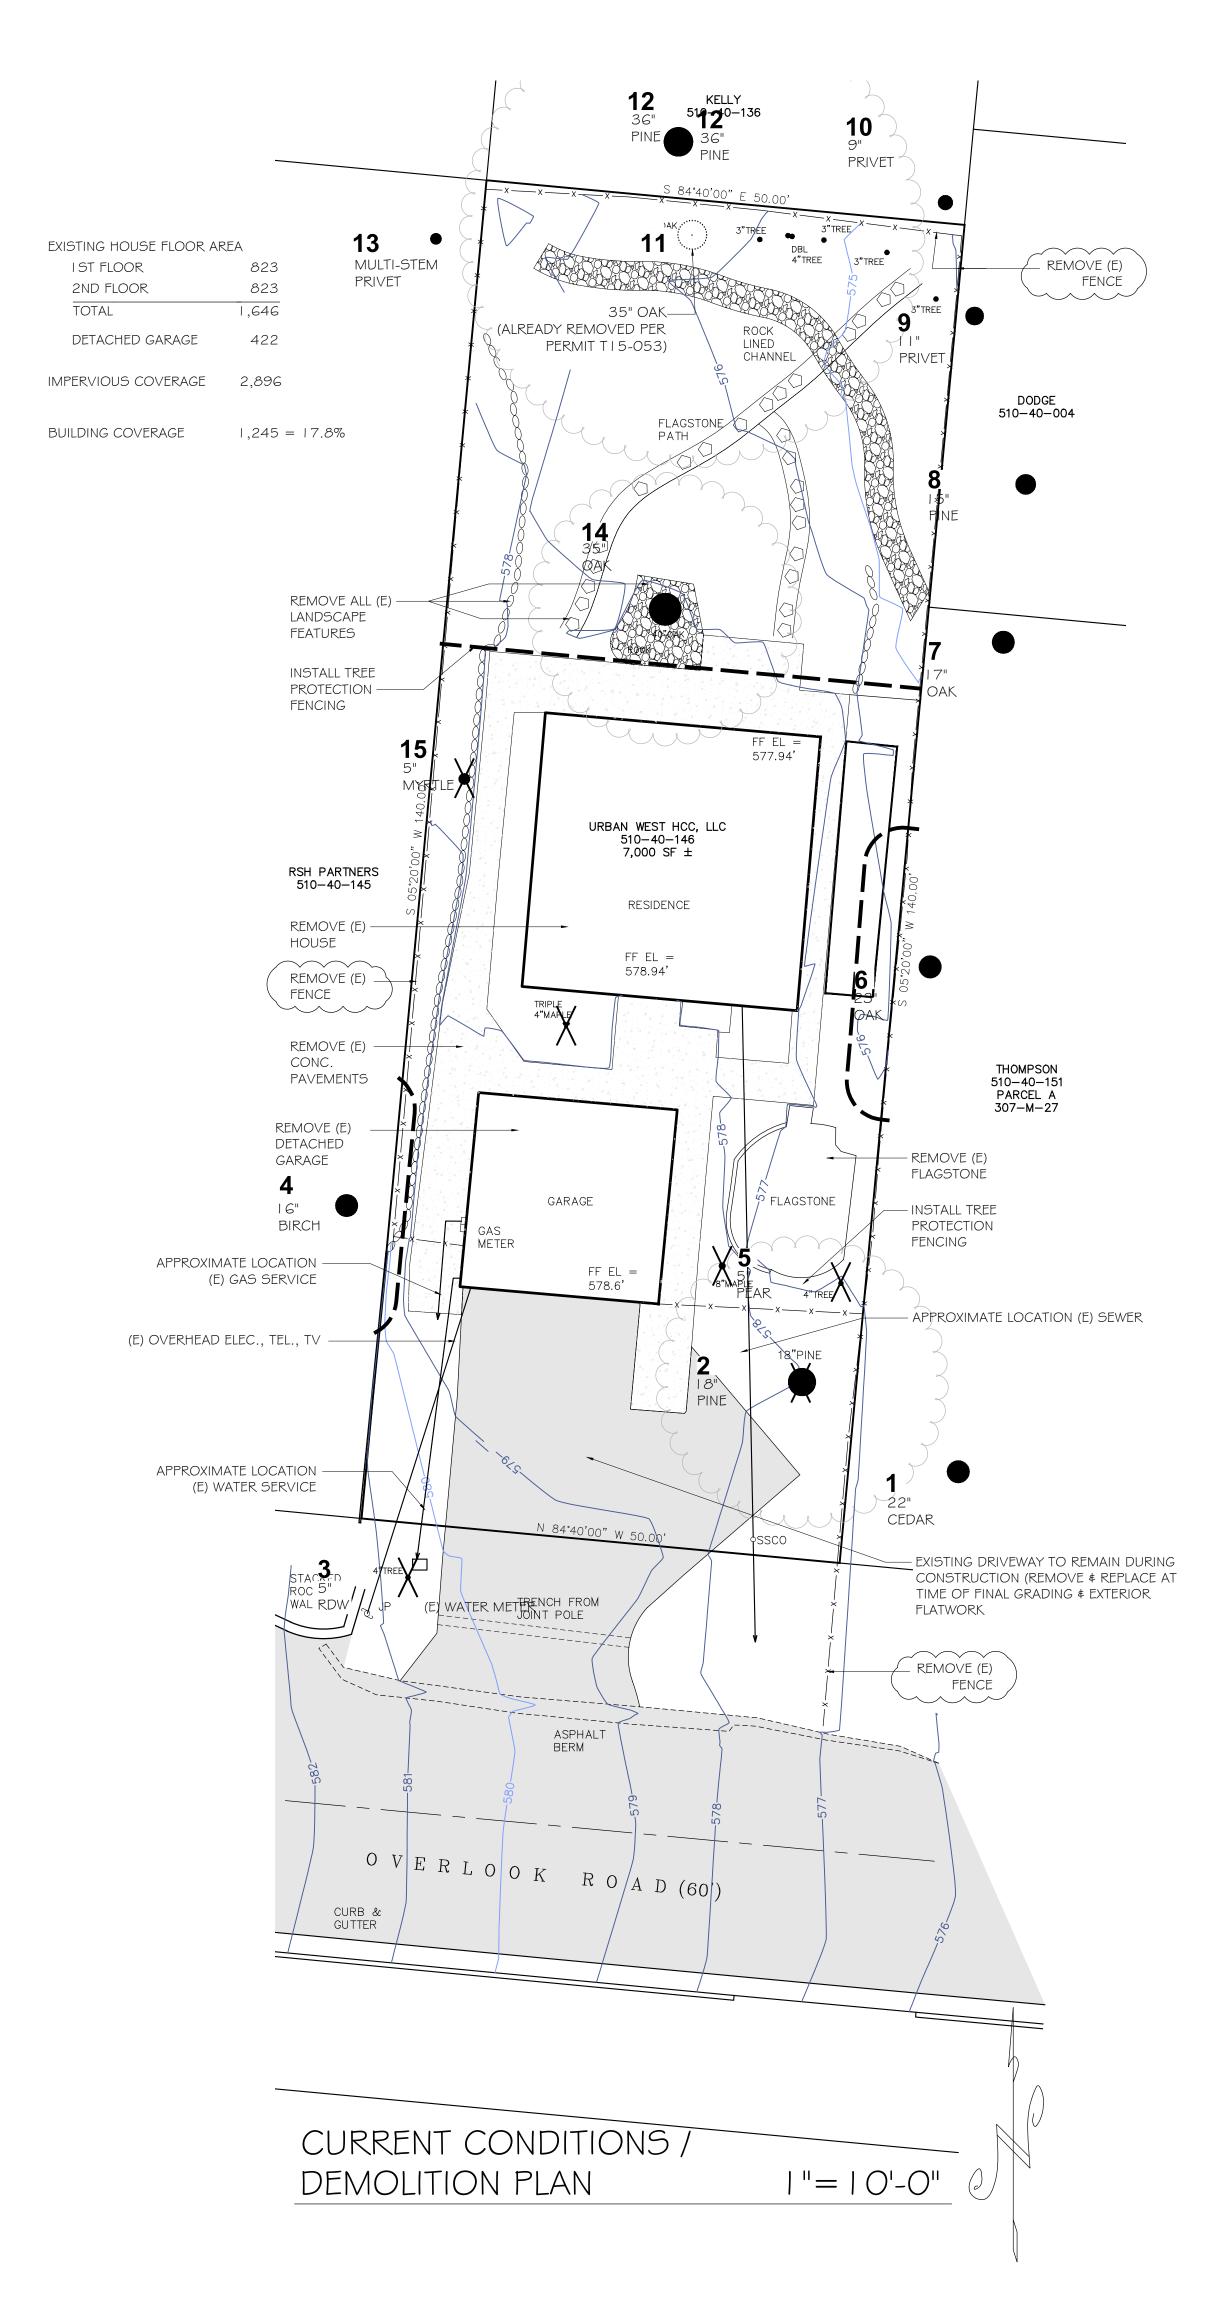

CHRIS SPAULDING

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REVISIONS

9-22-14

db

6-25-15

9-24-15

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12-22-15

1-26-16

PRELIMINARY SET

DESIGN REVIEW SET


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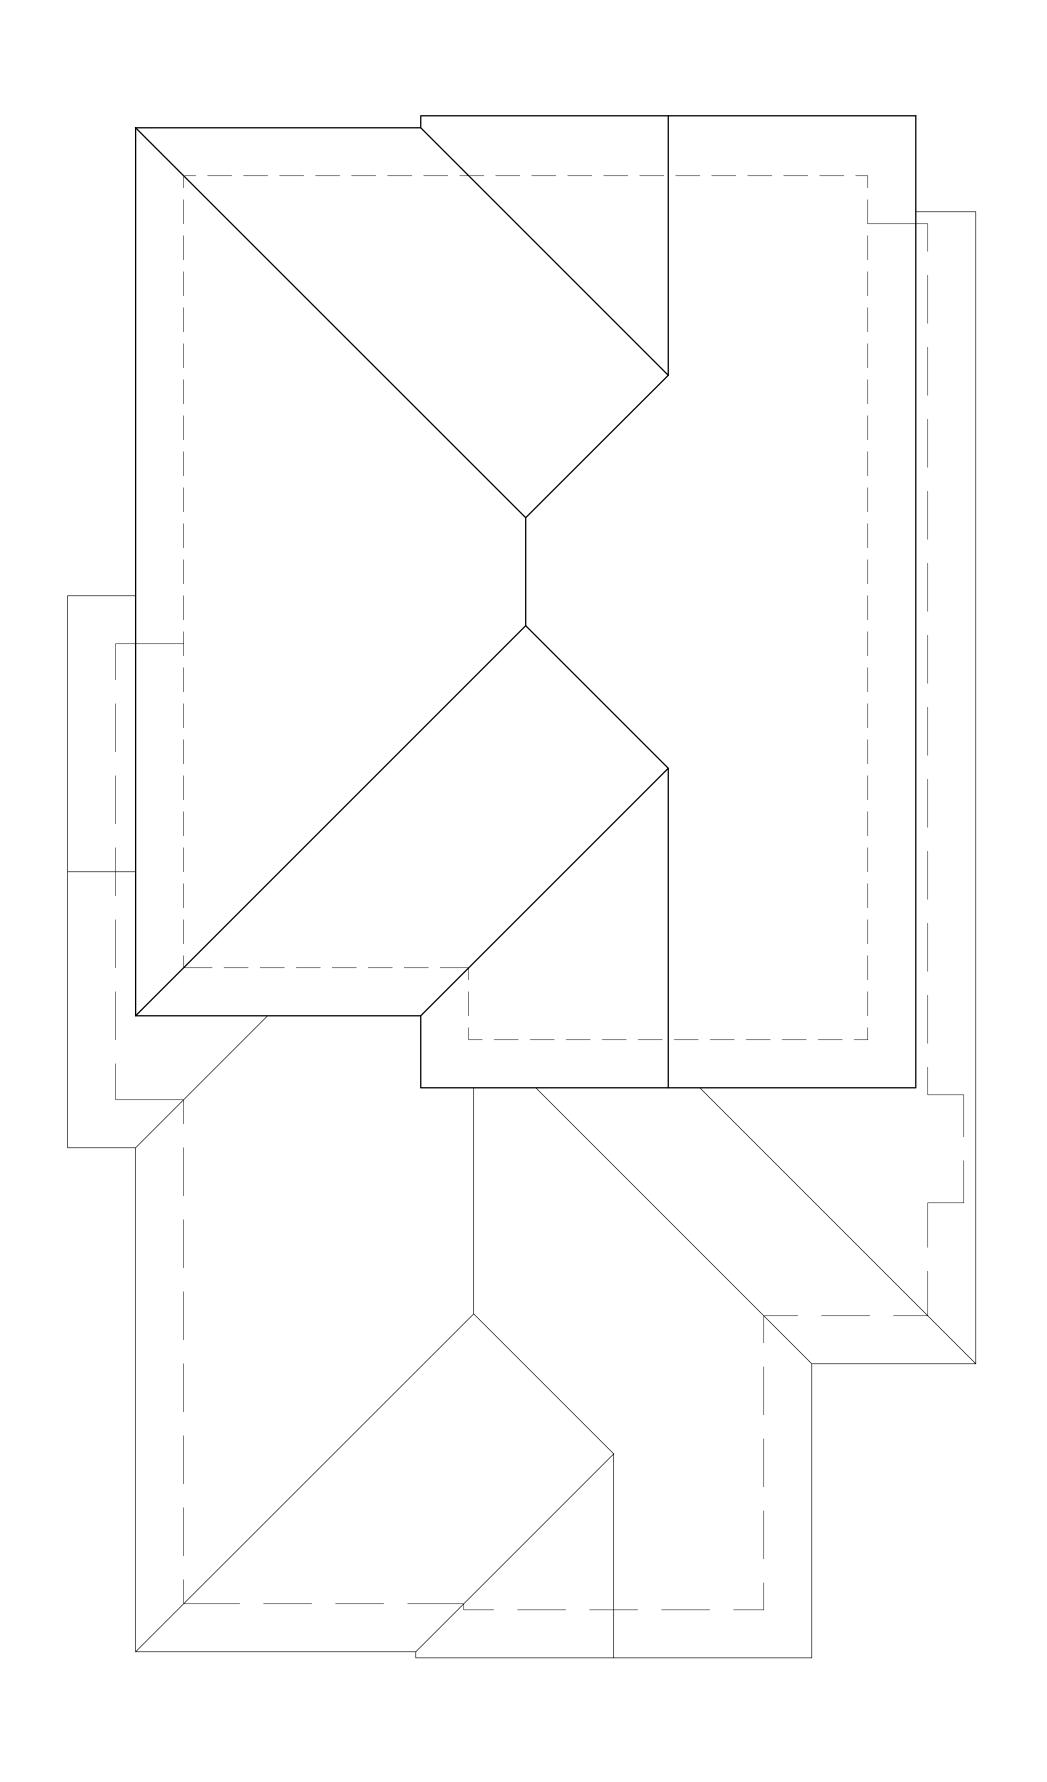
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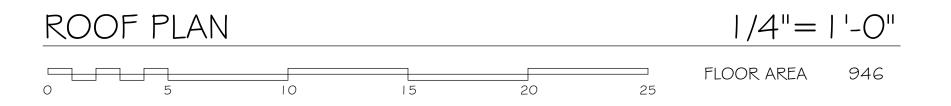
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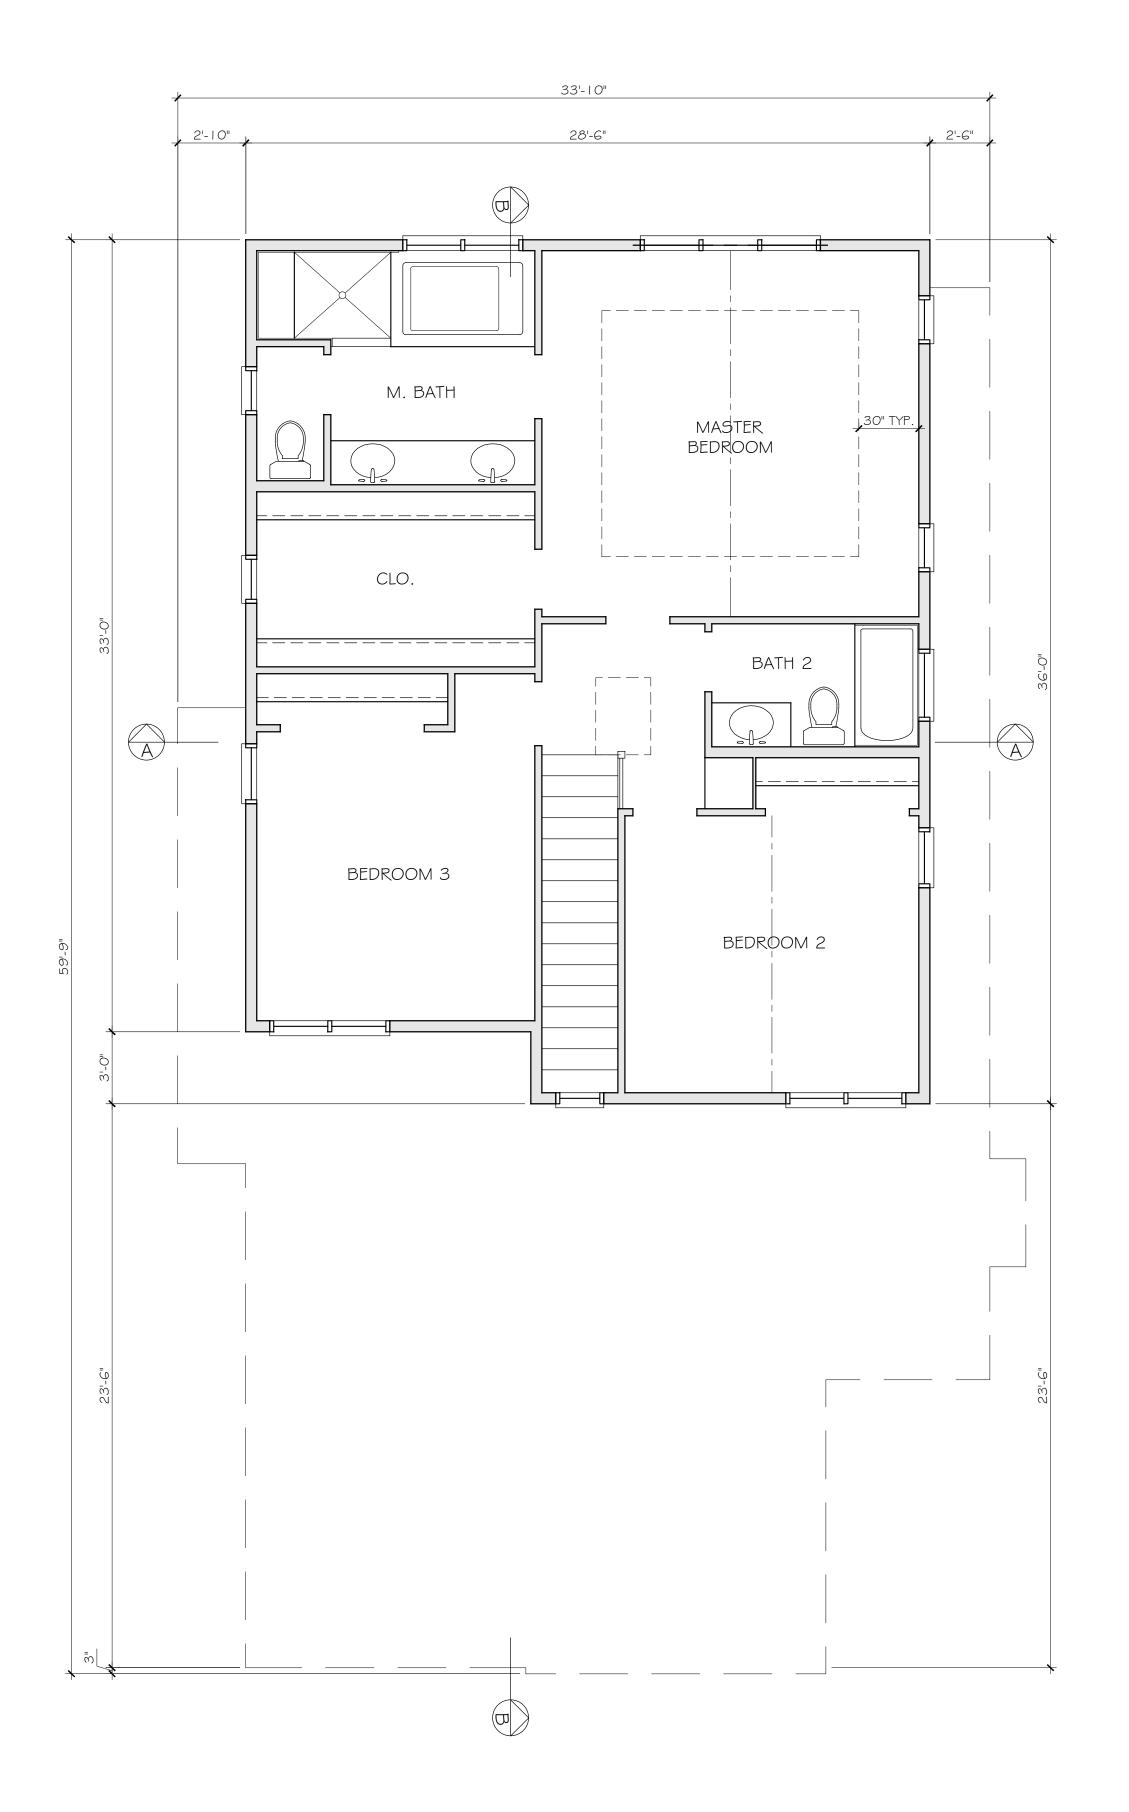
ROPOSED NEW HOME 1 OVERLOOK ROAD 3ATOS CALIFORNIA


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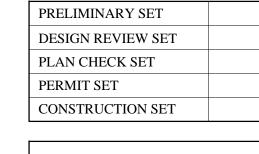
801 CAMELIA STREET SUITE E BERKELEY CALIFORNIA 94710 (510) 527-5997 FAX (510) 527-5999

REVISIONS BY

db

6-25-15	
9-24-15	
12-8-15	
12-22-15	
1-26-16	
PRELIMINARY SET	
DESIGN REVIEW SET	

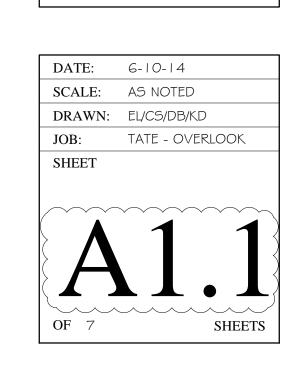9-22-14

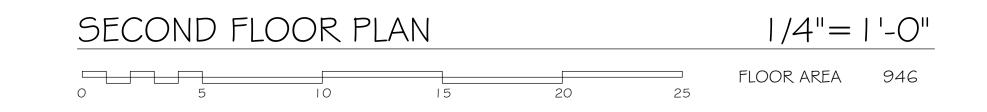

A PROPOSED NEW HOME 18151 OVERLOOK ROAD LOS GATOS CALIFORNIA

DATE: 6-10-14


SCALE: AS NOTED

DRAWN: EL/CS/DB/KD

JOB: TATE - OVERLOOK

SHEET

A3
OF 7 SHEETS

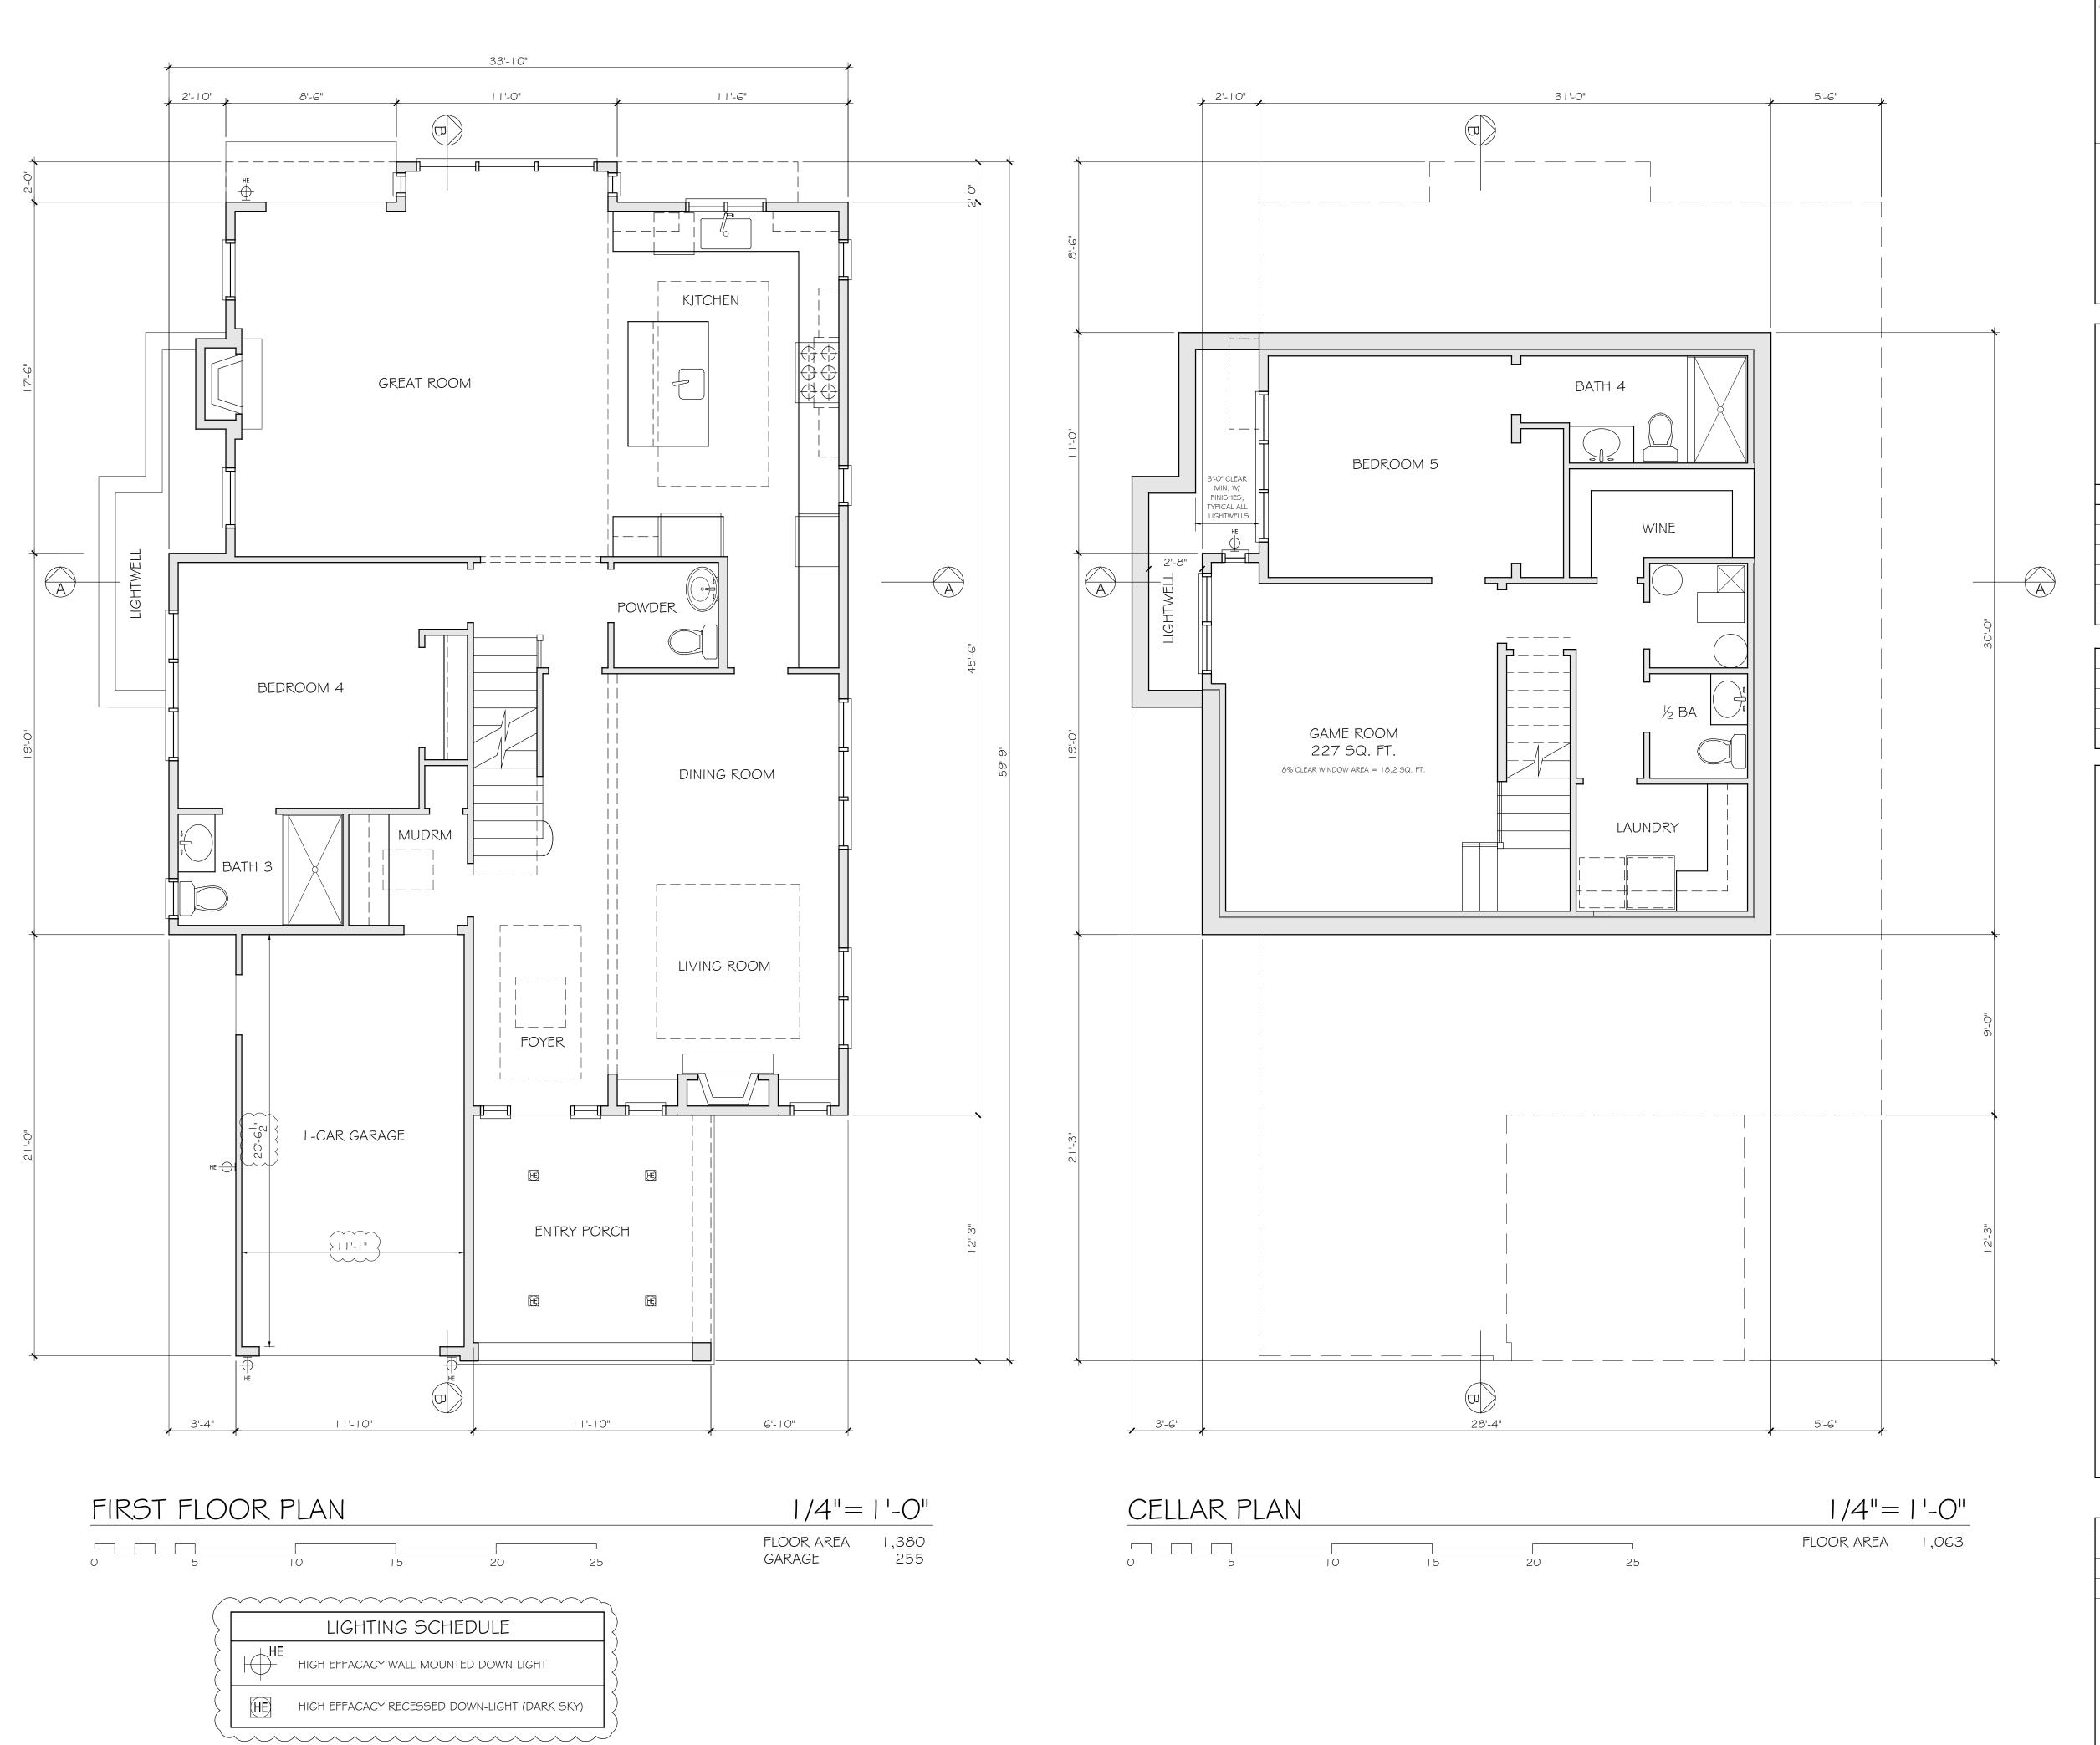

CHRIS SPAULDING

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REVISIONS BY

9-22-14 db

6-25-15

9-24-15

12-8-15

PRELIMINARY SET

DESIGN REVIEW SET

PLAN CHECK SET

PERMIT SET

CONSTRUCTION SET

12-22-15

1-26-16

A PROPOSED NEW HOME

18151 OVERLOOK ROAD

LOS GATOS

CALIFORNIA

DATE: 6-10-14

SCALE: AS NOTED

DRAWN: EL/CS/DB/KD

JOB: TATE - OVERLOOK
SHEET

OF 7 SHEETS





LEFT-SIDE ELEVATION




FRONT ELEVATION

1/4"= | '-0"







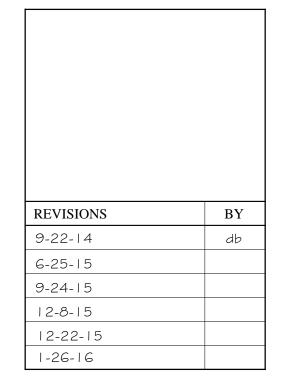



PRELIMINARY SET	
DESIGN REVIEW SET	
PLAN CHECK SET	
PERMIT SET	
CONSTRUCTION SET	

1/4"= | '-0"

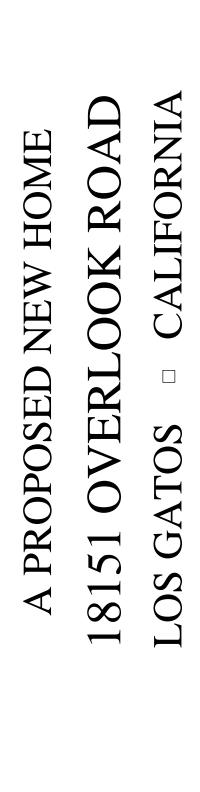


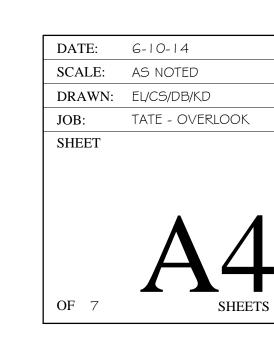

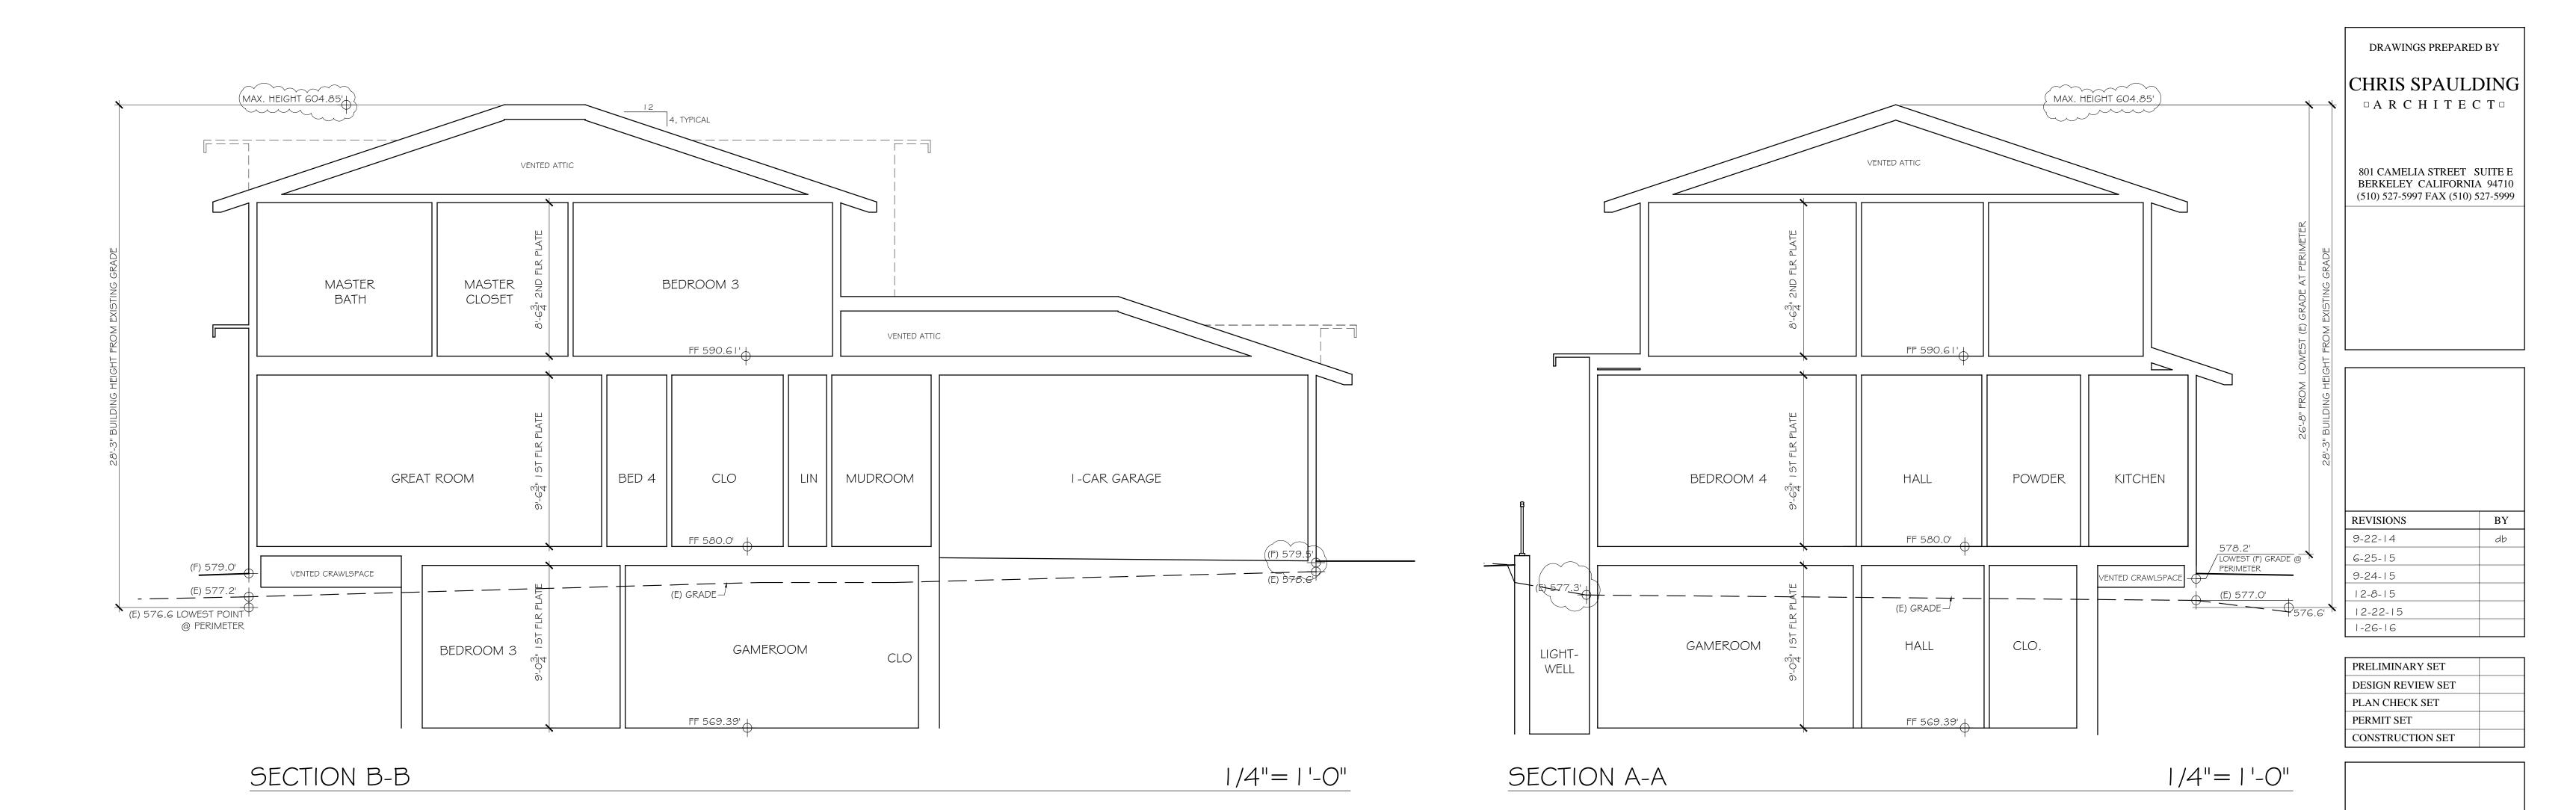

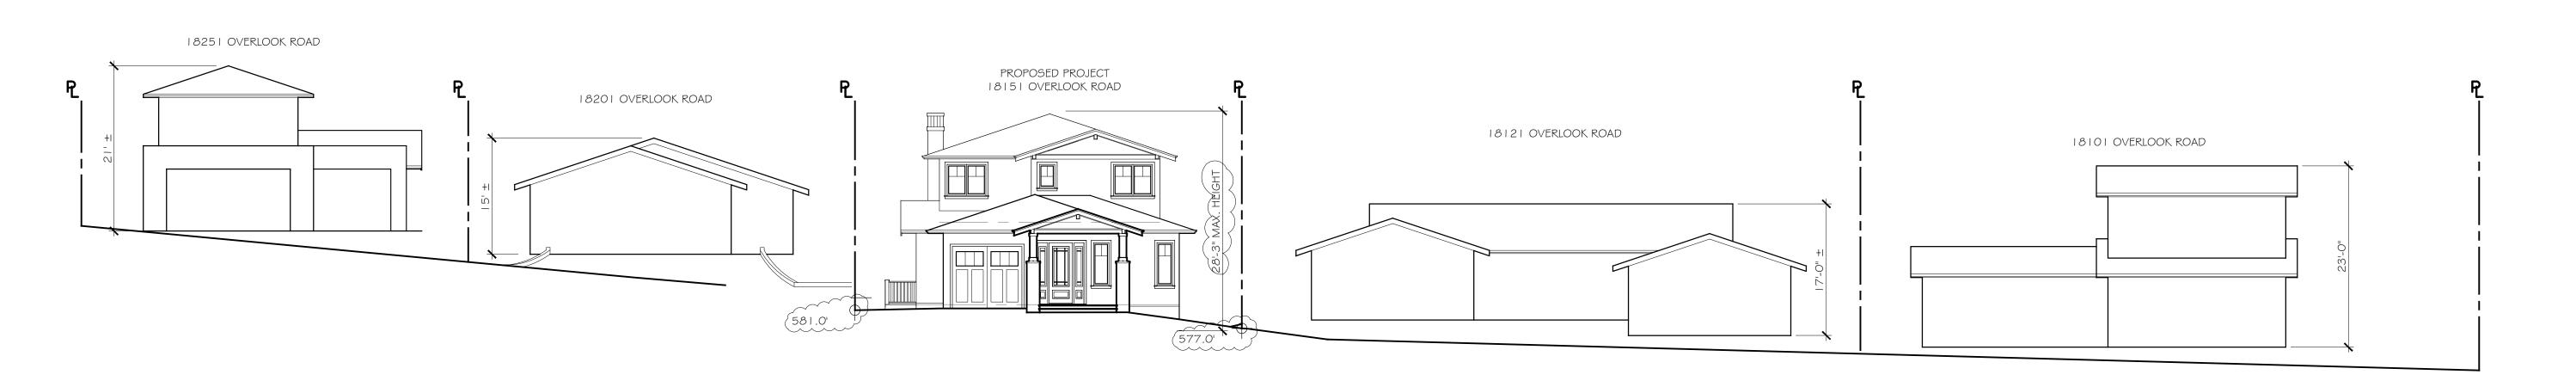

OVERLOOK ROAD STREET VIEW TOWARDS PROPOSED PROJECT 3/32"= 1'-0"

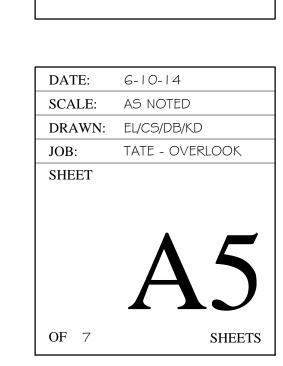

holes are manually dug using a post hole digger or shovel, and roots two inches and

greater in diameter retained and protected during the process (in the event a root of

this size is encountered during digging, the hole should be shifted over 12 inches and

32. Spoils created during digging shall not be piled or spread on unpaved ground within

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18151 Overlook Road, Los Gatos

Town of Los Gatos Community Development Department

a TPZ. If essential, spoils can be temporarily piled on plywood or a tarp.

the process repeated).

18151 Overlook Road, Los Gatos

Town of Los Gatos Community Development Department

mechanically excavated using heavy equipment, and remaining outside the fenced

area(s). Alternatively, the use of a **stump grinder** could be utilized precisely where a

26. Any approved digging or trenching within a TPZ shall be manually performed

without the use of heavy equipment or tractors operating on unpaved ground beneath

Page 10 of 13

curb/gutter and any overcut (12" max) will be established.

18151 Overlook Road, Los Gatos

Town of Los Gatos Community Development Department

signs shall be affixed and prominently displayed on each side of fencing opposite the

trees' trunks: "WARNING - Tree Protection Zone - this fence shall not be removed

and is subject to penalty according to Town Code 29.10.1025." These signs should

Page 9 of 13

be intact prior to commencing demolition.

Town of Los Gatos Community Development Department

18151 Overlook Road, Los Gatos

DRAWINGS PREPARED BY

CHRIS SPAULDING \Box A R C H I T E C T \Box

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REVISIONS BY9-22-14 db 6-25-15 9-24-15 12-8-15 12-22-15 1-26-16

PRELIMINARY SET **DESIGN REVIEW SET** PLAN CHECK SET PERMIT SET **CONSTRUCTION SET**

HOME OR NE S OPO PR

September 21, 2015

Date: September 21, 2015

Page 13 of 13

Prepared By: M.W

Town of Los Gatos Community Development Department

18151 Overlook Road, Los Gatos

Page 12 of 13

Registered Consulting Arborist® #399


Board-Certified Master Arborist® #WE-4001B

DATE: 6-10-14 SCALE: AS NOTED DRAWN: EL/CS/DB/KD

SHEET

OF 7

TATE - OVERLOOK

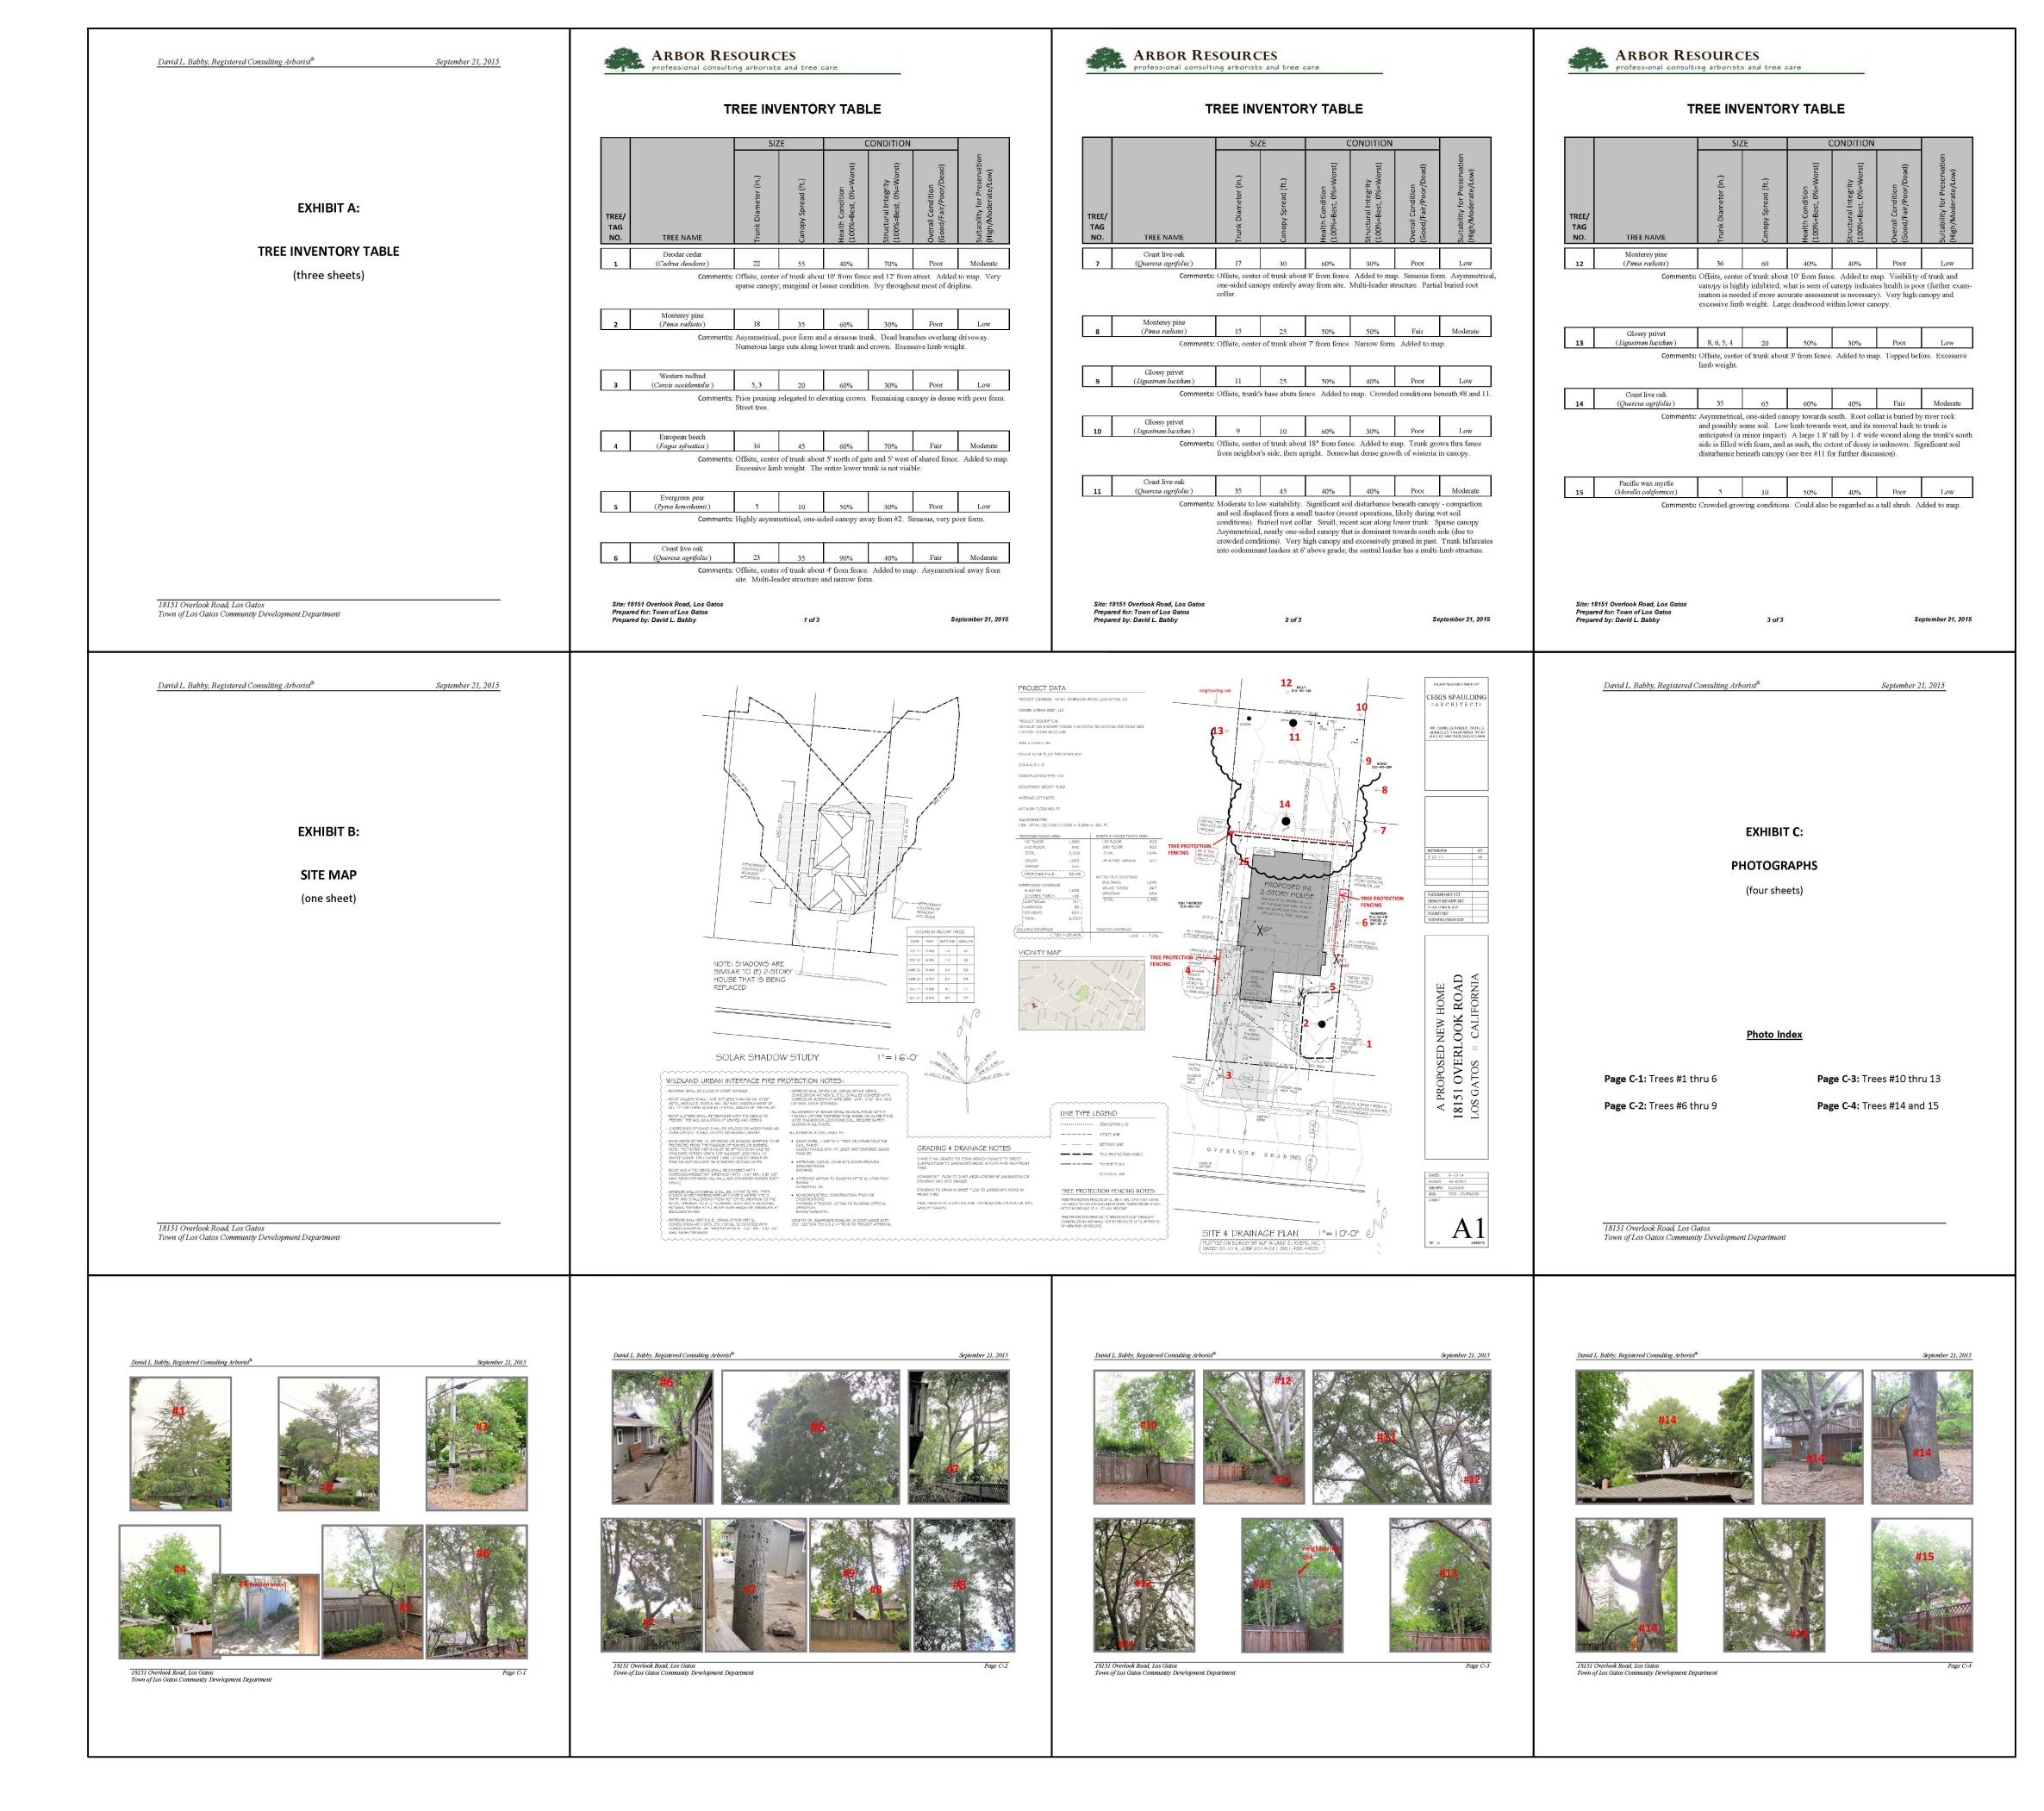

CHRIS SPAULDING

-- A R C H I T E C T --

801 CAMELIA STREET SUITE E BERKELEY CALIFORNIA 94710 (510) 527-5997 FAX (510) 527-5999

REVISIONS BY
9-22-14 db
6-25-15
9-24-15
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12-22-15
1-26-16

PRELIMINARY SET

DESIGN REVIEW SET

PLAN CHECK SET

PERMIT SET

CONSTRUCTION SET

A PROPOSED NEW HOME 18151 OVERLOOK ROAD LOS GATOS CALIFORNIA


DATE: 6-10-14

SCALE: AS NOTED

DRAWN: EL/CS/DB/KD

JOB: TATE - OVERLOOK



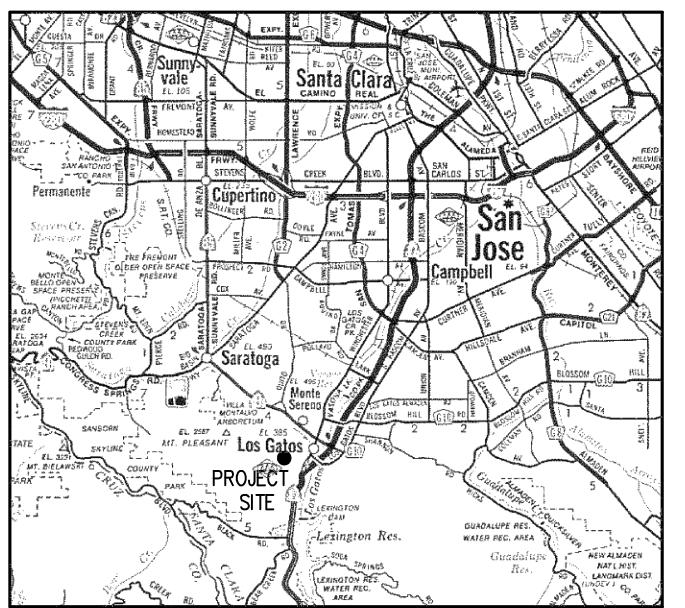

Preliminary Grading & Drainage Plans

HANNA & BRUNETTI EXP. 6-30-17 EXPIRES 6-30-17

CONTOUR ELEVATION

TOP OF CURB ELEVATION

PORTLAND CONCRETE ELEVATION

ASPHALT CONCRETE ELEVATION

TOP OF GRATE ELEVATION

BOTTOM OF WALL ELEVATION

TOP OF WALL ELEVATION

PIPE INVERT ELEVATION

FLOWLINE ELEVATION

ELECTROLIER FLOW DIRECTION

DROP INLET MANHOLE

CURB INLET

WATER METER

FIRE HYDRANT

WATER VALVE

RETAINING WALL

SEWER LATERAL

FIRE HYDRANT

GAS LINE

GAS METER

GATE VALVE

HIGH POINT

IRON PIPE

JOINT POLE

LOW POINT

MINIMUM

PULL BOX

NOT IN CONTRACT

OVERHEAD UTILITY

PUBLIC SERVICE EASEMENT

P.S.D.E. PRIVATE STORM DRAIN EASEMENT

PVI POINT OF VERTICAL INTERSECTION

REINFORCED CONCRETE PIPE

PROPERTY LINE

RIGHT OF WAY

STM STORM DRAIN MANHOLE

STORM DRAIN PIPE

SSMH SANITARY SEWER MANHOLE

SANITARY SEWER PIPE

MIN

R/W

INVERT OF PIP

GUY WIRE FOR POLE

TREE TO BE REMOVED

(length) LF (size) SD • S=(grade) STORM DRAIN (length) LF (size) SS • S=(grade) SANITARY SEWER

INV 457.35

PCC 257.65

FL 125.48

AC 359.45

TG 359.45

TW 359.45

BW 458.25

LEGEND

tc 236.56

pcc 259.56

fl 158.95

tg 365.75

tw 365.75

ABBREVIATIONS

AREA DRAIN

BACK OF CURB

BARBWIRE FENCE

CATCH BASIN

CURB INLET

CENTERLINE

CONCRETE

DRAIN BOX

DRIVEWAY

ELEVATION

EXISTING

ELECTRIC LINE

END OF CURVE

EXISTING GRADE

END OF RETURN

FINISH FLOOR

FINISH GRADE

EDGE OF PAVEMENT

DROP INLET

DUCTILE IRON PIPE

CABLE TELEVISION

CORRUGATED METAL PIPE

BUILDING

BLOW OFF

AGGREGATE BASE

BEGINNING OF CURVE

18151 Overlook Road

APN 510-40-146

in the

Town of Los Gatos

PROJECT AREA

PROJECT SUMMARY

ASSESSOR'S PARCEL NUMBER

EXISTING IMPERVIOUS AREAS

TOTAL

Santa Clara County, California

VICINITY MAP

TOWN OF LOS GATOS STANDARD GRADING NOTES

- 1. All work shall conform to Chapter 12 of the Town of Los Gatos Grading Ordinance, the adopted California Building Code and the latest edition of the Standard Specifications for Public Works Construction except as specified otherwise on these plans and details.
- No work may be started on-site without an approved Grading Plan and a Grading Permit issued by the Town of Los Gatos, Public Works Department located at 41 Miles Avenue, Los Gatos, CA 95030
- A Pre-Job meeting shall be held with the Town Engineering Inspector from the Department of Parks and Public Works prior to any work being done. The Contractor shall call the Inspections Line at 408.399.5771 at least 48 hours prior to any grading or onsite work. This meeting should include: a. A discussion of the project conditions of approval, working hours,
 - site maintenance and other construction matters; Acknowledgement in writing that Contractor and Applicant have read and understand the project conditions of approval, and will make certain that all project sub-contractors have read and understand them prior to commencing work and that a copy of the project conditions of approval will be posted on site at all times
- Approval of plans does not release the developer of the responsibility for the correction of mistakes, errors, or omissions contained therein. If, during the course of construction of the improvements, public interest and safety requires a modification or departure from the Town Specifications or these improvement plans, the Town Engineer shall have full authority to require such modification or departure and to specify the manner in which the same is to be made.
- Approval of this plan applies only to the grading, excavation, placement, and compaction of natural earth materials. This approval does not confer any rights of entry to either public property or the private property of others
- 3. Excavated material shall be placed in the fill areas designated or shall be hauled away from the site to be disposed of at approved location(s).

and does not constitute approval of any other improvements.

- 7. It shall be the responsibility of the Permittee or Contractor to identify. locate and protect all underground facilities. Permittee or Contractor shall notify USA (Underground Service Alert) at 1-800-227-2600 a minimum of 48 hours but not more than 14 days prior to commencing all work.
- 8. All grading shall be performed in such a manner as to comply with the standards established by the Air Quality Management District for airborne particulates.
- 9. The Contractor shall comply with all local, state and federal laws, codes. rules and regulations governing the work identified on these plans. These shall include, without limitation, safety and health rules and regulations established by or pursuant to the Occupational Safety and Health Act or any other applicable public authority.
- 10. The General Contractor shall provide qualified supervision on the job site at all times during construction.
- 11. Horizontal and vertical controls shall be set and certified by a licensed surveyor or registered civil engineer qualified to practice land surveying,
- a. Retaining wall--top of wall elevations and locations (all walls to be permitted separately and applied for at the Town of Los Gatos
- Building Department). b. Toe and top of cut and fill slopes

Town either by letter or by signing the plans.

12. Prior to issuance of any permit, the applicant's soils engineer shall review the final grading and drainage plans to ensure that designs for foundations, retaining walls, site grading, and site drainage are in accordance with their recommendations and the peer review comments. The applicant's soils engineer's approval shall then be conveyed to the

Reference Report	No	, dated	, 20
Letter No.	, dated	, 20, shall	be thoroughly

13. During construction, all excavations and grading shall be inspected by the applicant's soils engineer. The engineer shall be notified at least 48 hours before beginning any grading. The engineer shall be onsite to verify that the actual conditions are as anticipated in the design-level geotechnical report and/or provide appropriate changes to the report recommendations, as necessary. All unobserved and/or unapproved grading shall be removed and replaced under soils engineer observance (the Town Inspector shall be made aware of any required changes prior to work being performed).

- 15. All private and public streets accessing Project Site shall be kept open and in a safe, drive-able condition throughout construction. If temporary closure is needed, then formal written notice to the adjacent neighbors and the Town of Los Gatos Public Works Department shall be provided at least one week in advance of closure and no closure shall be granted without the express written approval of the Town. No material or
- 16. The contractor shall install and maintain fences, barriers, lights and signs that are necessary to give adequate warning and/protection to the public

18. General Contractor (If available): _	Phone:
19. Grading Contractor (If available): _	Phone:
	House

17. Owner/Applicant:

by the Town Engineer.

- b. Fill: $96\pm$ CY Import: fill $4\pm$ c.y. fill $0\pm$ c.y. fill $0\pm$ c.y. fill $103\pm$ c.y. 21. Water shall be available on the site at all times during grading operations
- permits and methods of tree preservation shall be required. Tree
- responsible coordinating inspection performed by other governmental
- 25. It is the responsibility of contractor and/or owner to make sure that all dirt
- 26. Good housekeeping practices shall be observed at all times during the course of construction. Superintendence of construction shall be diligently performed by a person or persons authorized to do so at all times during working hours. The storing of goods and/or materials on the sidewalk and/or the street will not be allowed unless a special permit is issued by the Engineering Division. The adjacent public right-of-way shall be kept clear of all job related dirt and debris at the end of the day. Failure to maintain the public right-of-way according to this condition may result in the Town performing the required maintenance at the developer's
- 27. Grading shall be undertaken in accordance with conditions and requirements of the project Storm Water Pollution Control Plan and/or Storm Water Pollution Prevention Plan, the Town of Los Gatos Storm Water Quality Management Program, National Pollutant Discharge Elimination System (NPDES) and any other permits/requirements issued by the State of California Regional Water Quality Control Board. Plans (including all updates) shall be onsite at all times. No direct storm water discharges from development will be allowed onto Town streets or onto the public storm drain system without treatment by an approved storm water pollution prevention device or other approved methods. Maintenance of private storm water pollution prevention devices shall be the sole responsibility of the owner. Discharges or connection without treatment by an approved and adequately operating storm water pollution prevention device or other approved method shall be considered a violation of the above referenced permit and the Town of Los Gatos

14. The results of the construction observation and testing should be
documented in an "as-built" letter/report prepared by the applicants' soils
engineer and submitted for the Town's review and acceptance before final
release of any occupancy permit is granted.

equipment shall be stored in the public or private right-of-way.

44			
ding Contractor (If available):	Ph	one:	
	House	Cellar	Dri
a. Cut: 561± CY Export: 465±	cut 56±	c.y. cut 457± c.y.	cut
h Fill: 06+ CV Import:	£:11 / 1	ov fill Or ov	£:11

to properly maintain dust control.

22. This plan does not approve the removal of trees. Appropriate tree removal Removal Permits are required prior to the approval of all plans.

- 23. A Town Encroachment Permit is required for any work within the public right-of-way. A State Encroachment Permit is required for any work within State right-of-way (if applicable). The Permittee and/or Contractor shall be
- 24. No cross lot drainage will be permitted without satisfactory storm water acceptance deed/facilities. All drainage shall be directed to the street or other acceptable drainage facility via a non-erosive method as approved
- tracked into the public right-of-way is cleaned up on a daily basis. Mud, silt, concrete and other construction debris SHALL NOT be washed into the Town's storm drains.
- Stormwater Ordinance.

PROPOSED BUILDING AREA FIRST FLOOR 1,380 SF SECOND FLOOR 946 SF TOTAL 2,326 SF CELLAR 819 SF GARAGE 244 SF PROPOSED IMPERVIOUS AREAS HOUSE 1,380 SF 244 SF GARAGE COVERED PORCHES 145 SF LIGHTWELL & LANDING 1,874 SF TOTAL EXISTING HOUSE FLOOR AREA FIRST FLOOR 823 SF SECOND FLOOR 823 SF DETACHED GARAGE 966 SF CONCRETE WALK

NPDES NOTES

1. Sediment from areas disturbed by construction shall be retained on site using structural controls as required by the statewide General Construction Stormwater

2. Stockpiles of soil shall be properly contained to minimize sediment transport from the site to streets, drainage facilities or adjacent properties via runoff, vehicle tracking, or wind as required by the statewide General Construction Stormwater Permit.

- 3. Appropriate BMPs for construction-related materials, wastes, spill or resides shall be Implemented to minimize transport from the site to streets, drainage facilities, or adjoining property by wind or runoff as required by the statewide General Construction Stormwater Permit.
- 4. Runoff from equipment and vehicle washing shall be contained at construction sites and must not be discharged to receiving waters or to the local storm drain system.
- 5. All construction contractor and subcontractor personnel are to be made aware of the required best management practices and good housekeeping measures for the project site and any associated construction staging areas.
- 6. At the end of each day of construction activity all construction debris and waste materials shall be collected and properly disposed in trash or recycle bins.
- 7. Construction sites shall be maintained in such a condition that a storm does not carry Wastes or pollutants off the site. Discharges of material other than stormwater (nonstormwater discharges) are prohibited except as authorized by an individual NPDES permit or the statewide General Construction Stormwater Permit. Potential pollutants include but are not limited to: solid or liquid chemical spills; wastes from paints, stains, sealants, solvents, detergents, glues, lime, pesticides, herbicides, fertilizers, wood preservatives and asbestos fibers, paint flakes or stucco fragments; fuels, oils, lubricants, and hydraulic, radiator or battery fluids; concrete and related cutting or curing residues; floatable wastes; wastes from engine/equipment steam cleaning or chemical degreasing; wastes from street cleaning; and superchlorinated potable water from line flushing and testing. During construction, disposal of such materials should occur in a specified and

8. Discharging contaminated groundwater produced by dewatering groundwater that has infiltrated into the construction site is prohibited. Discharging of contaminated soils via surface erosion is also prohibited. Discharging non-contaminated groundwater produced by dewatering activities requires a National Pollutant Discharge Elimination System (NPDES) permit from the respective State Regional Water Quality Control

controlled temporary area on-site physically separated from potential stormwater runoff,

with ultimate disposal in accordance with local, state and federal requirements.

ELEVATION DATUM

2,895 SF

7,000 SQ. FT.

ELEVATIONS WERE BASED ON THE TOWN OF LOS GATOS BENCHMARK #33, BRASS DISK AT THE INTERSECTION OF PENNSYLVANIA AND WASHINGTON.

EL = 563.56 (NGVD 29)

BASIS OF BEARINGS

BEARINGS ARE BASED ON THE CENTERLINE OF OVERLOOK ROAD AS SHOWN ON THAT CERTIAIN TRACT MAP FILED IN BOOK E OF MAPS, PAGE 135, SANTA CLARA COUNTY

NORTH 84°40'00" WEST

FLOODZONE STATEMENT

COMMUNITY PANEL NUMBER: 06085C0376H MAP REVISED: MAY 18, 2009

PROJECT IS LOCATED IN ZONE X

AREAS OF 0.2% ANNUAL CHANCE FLOOD: AREAS OF 1% ANNUAL CHANCE FLOOD WITH AVERAGE DEPTHS OF LESS THAN 1 FOOT OR WITH DRAINAGE AREAS LESS THAN 1 SQUARE MILE; AND AREAS PROTECTED BY LEVEES FROM 1% ANNUAL CHANCE FLOOD.

OWNER

URBAN WEST, LLC 22 SOUTH SANTA CRUZ AVENUE LOS GATOS, CA 95030

CIVIL ENGINEER

HANNA & BRUNETTI 7651 EIGLEBERRY STREET GILROY, CA 95020 OFFICE: 408 842-2173 FAX: 408 842-3662

EMAIL: ENGINEERING@HANNABRUNETTI.COM

SHEET INDEX

COVER SHEET

EXISTING SITE

PRELIMINARY GRADING & DRAINAGE PLAN



STANDARD

TOP OF CURB

TOP OF BANK

TOE OF BANK

WATER LINE

WATER METER

WATER VALVE


TYPICAL


TOF


SIDEWALK


SHEET OF 3 JOB NO. 15025

Last updated: 8/18/2011

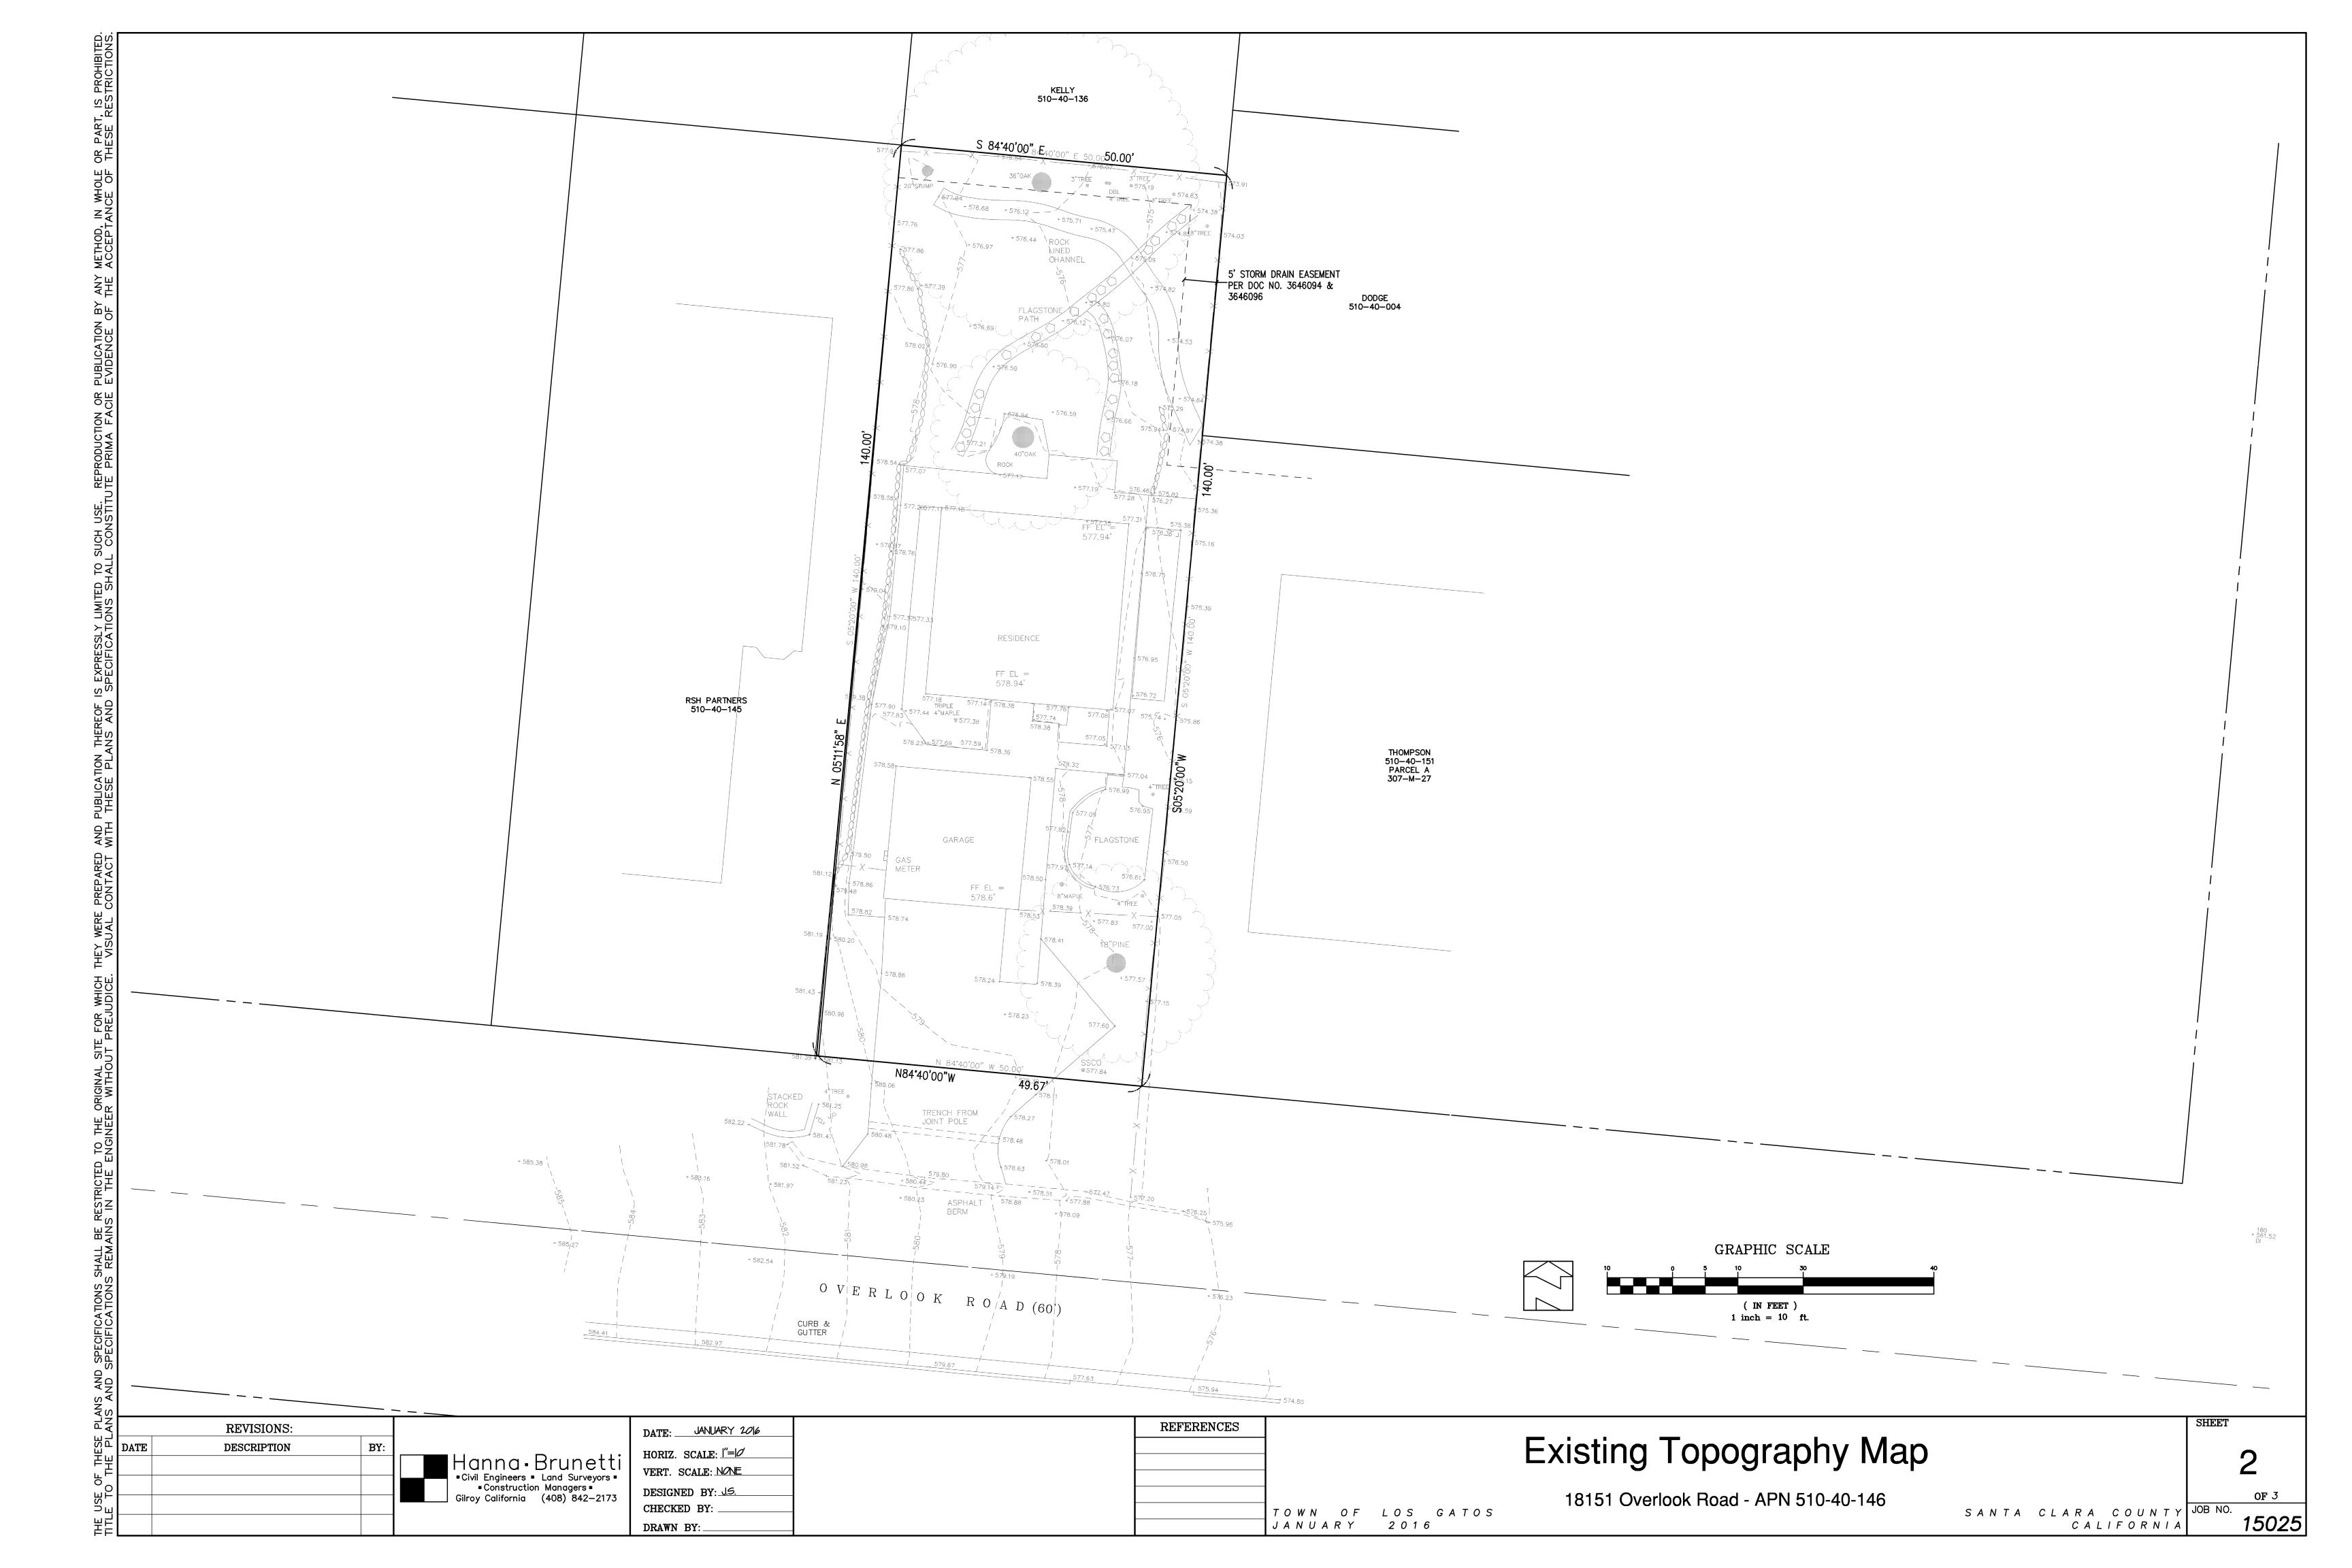

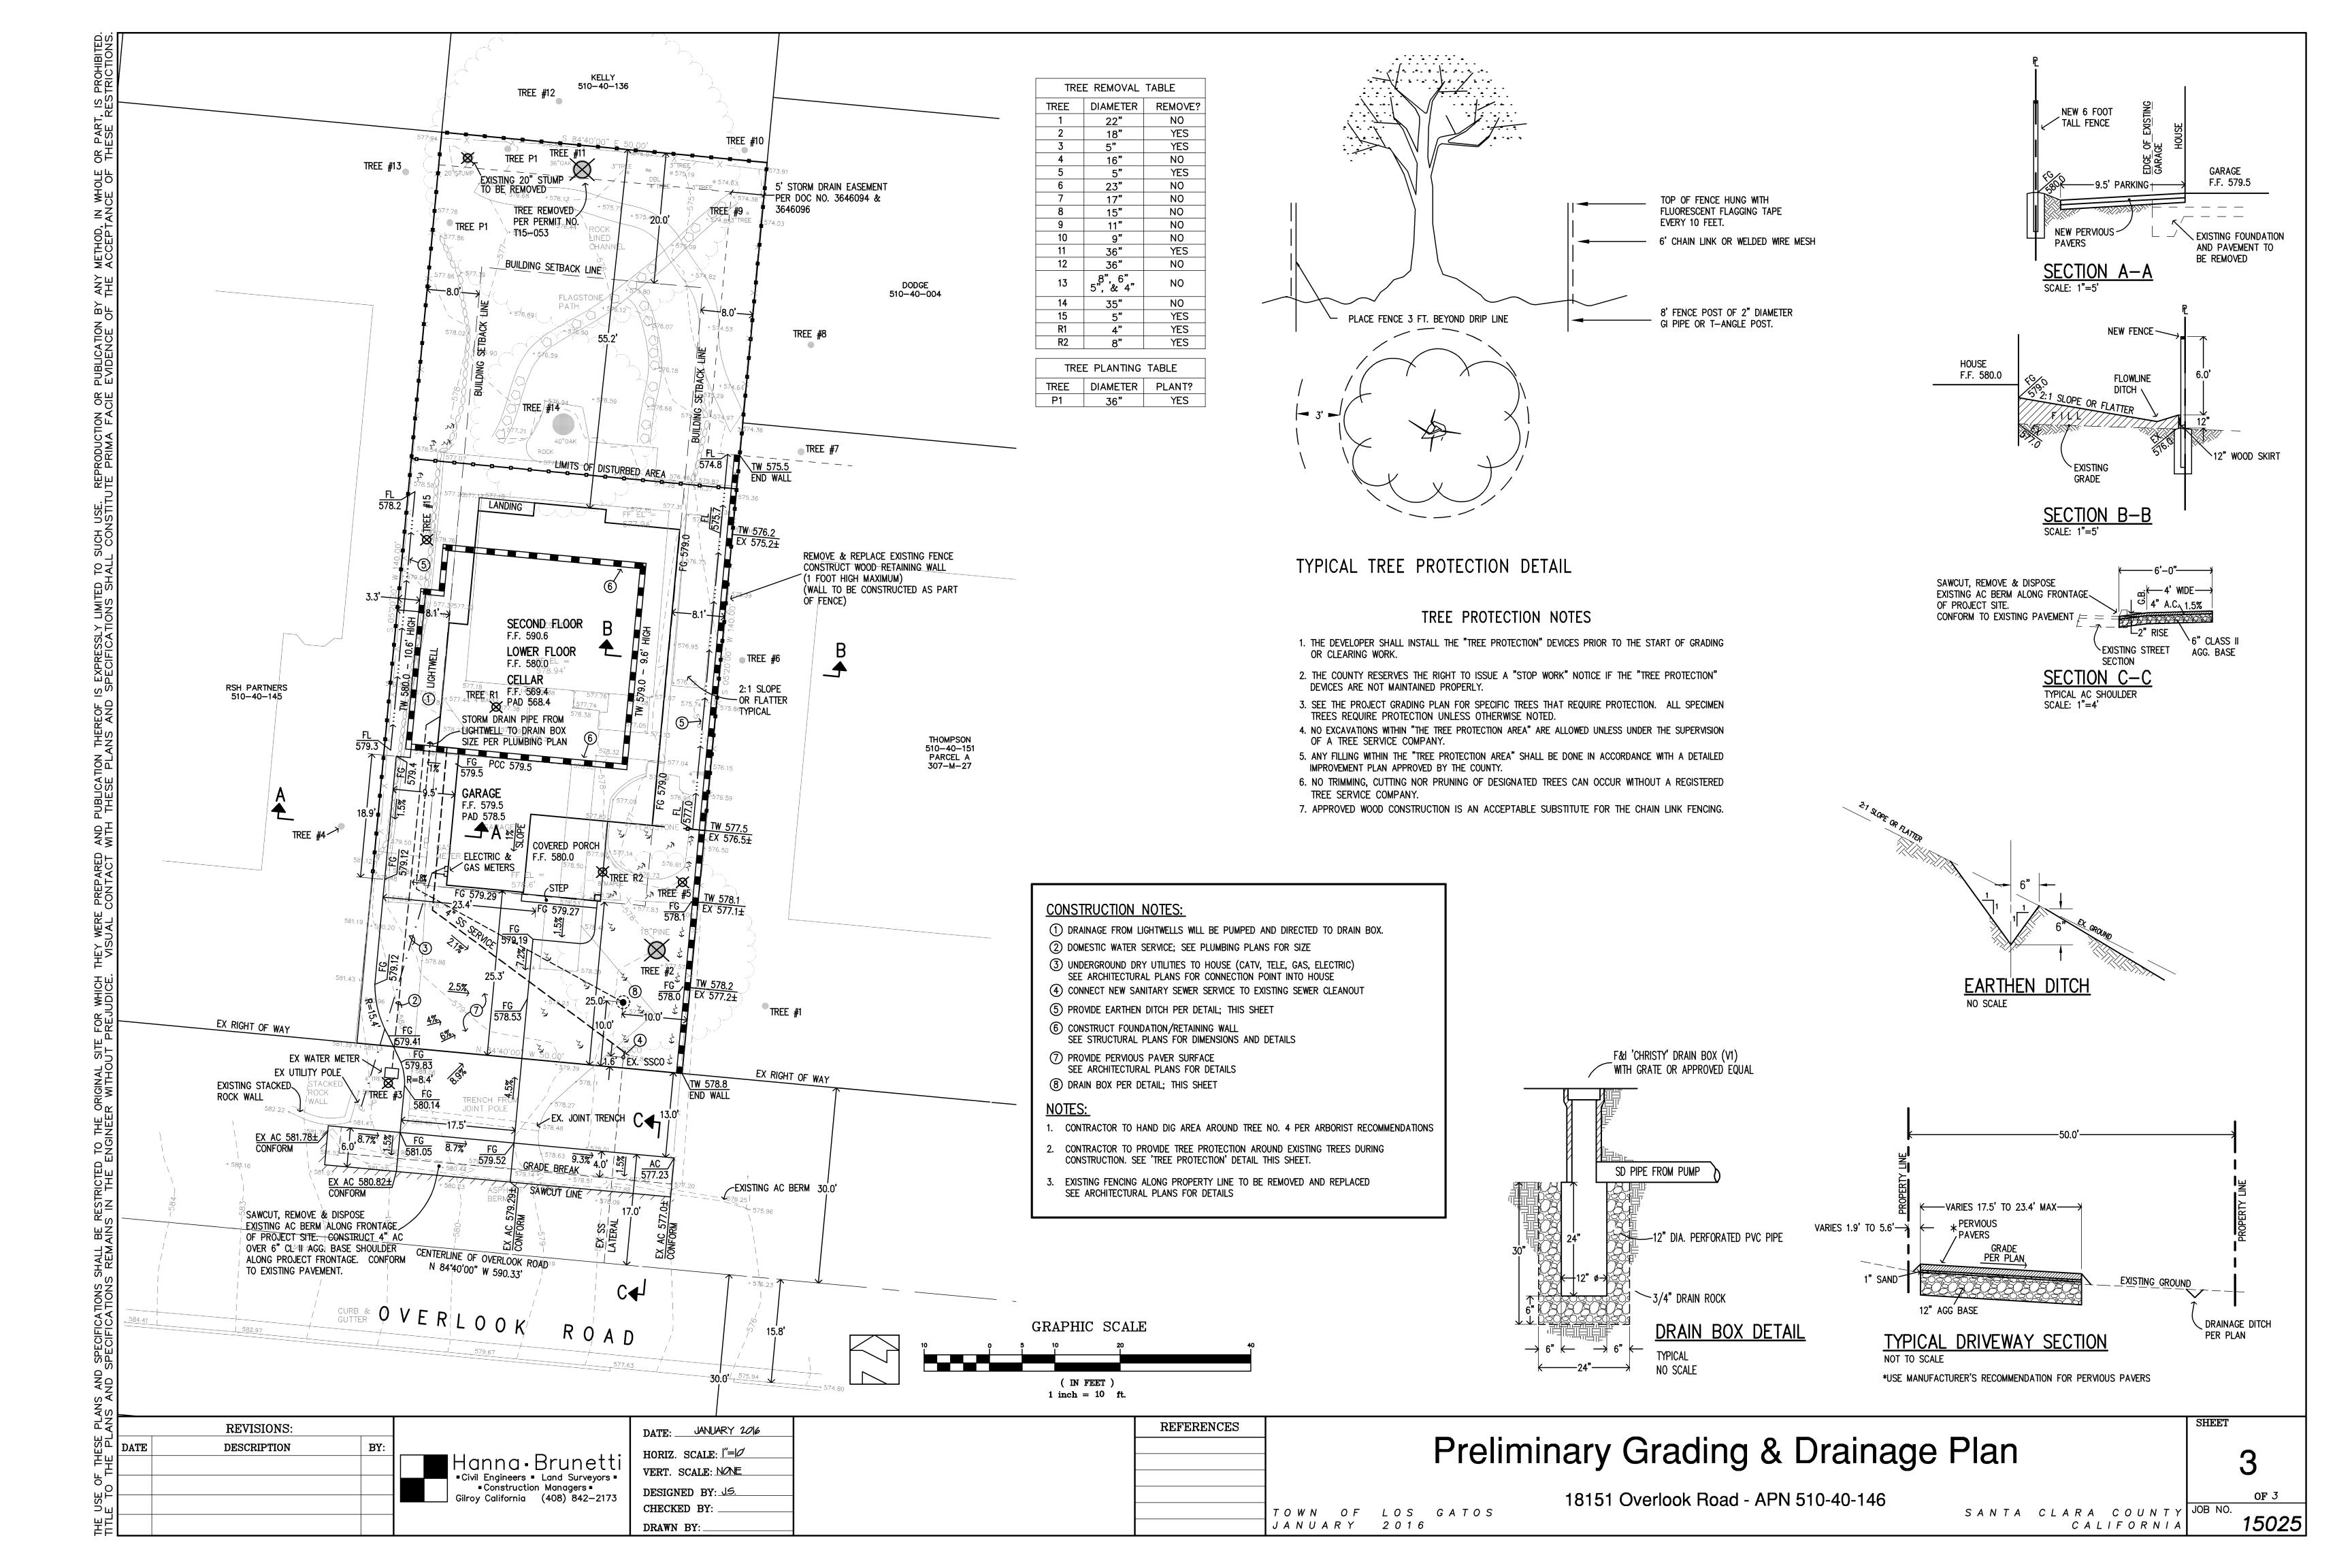

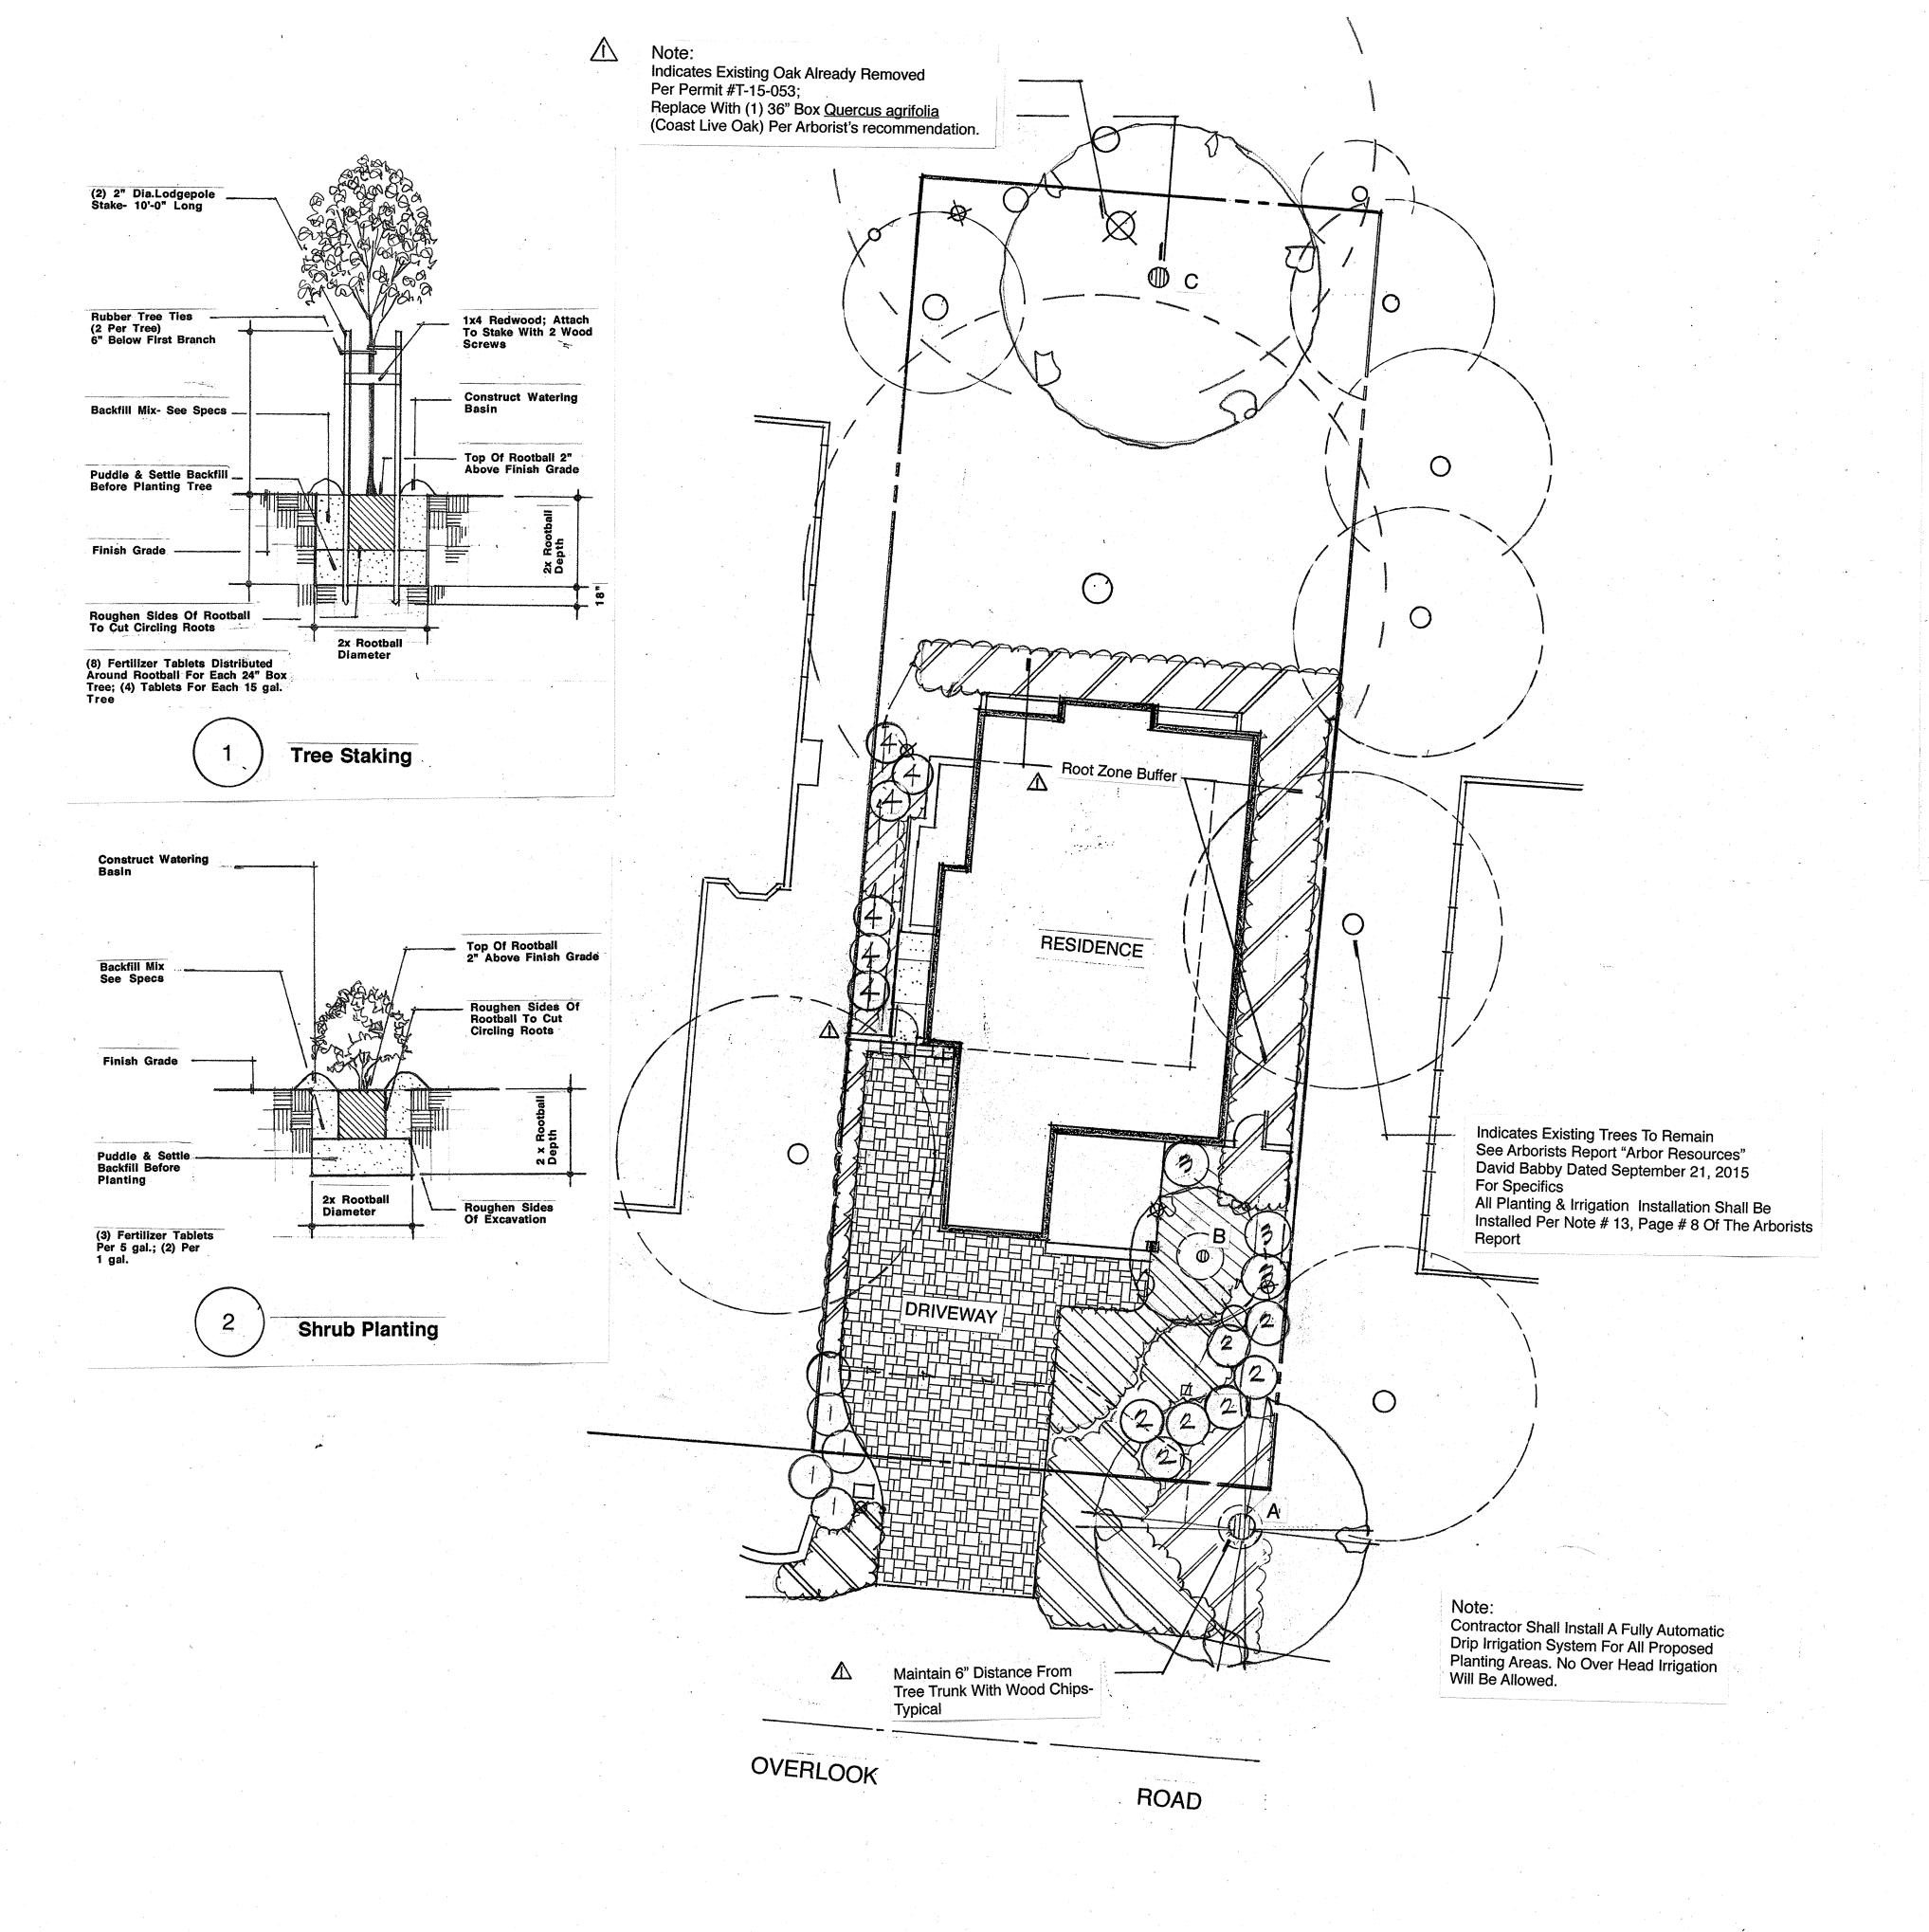


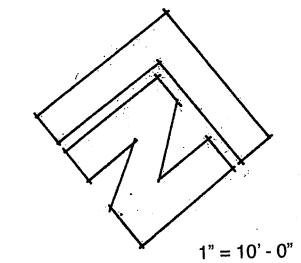


Plant Schedule:

	Symbol	Botanical Name	Common Name	Size	Water Rating	Quantity
\triangle	Trees:					Guarracy
	Α	Quercus kelloggii	California Black Oak	36" Box	L	1
	В	Cercis occidentalis	Western Redbud	36" Box	VL	1
	C	Quercus agrifolia	Coast Live Oak	36" Box	VL	1
$\Delta \Sigma$	Shrubs:					
•	1	Arctostaphylos d.'H.McMinn'	Manzanita	5 g.c.	L	5
	2 .	Westringia f.'Morning Light'	Coast Rosemary	5 g.c.	L	7
	3	Rhododendron m.'Chinoides'	Rhododendron	5 g.c.	M	3
	4	Polystichum munitum	Western Sword Fern	5 g.c.	M	6

Ground covers:

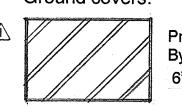

Premium Arbor Mulch By Lyngso Or Equal

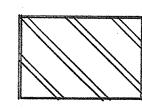

Carex divulsa Berkeley Sedge Plant 1 g.c. @ 24" o.c.


Dwarf Manzanita

Arctostaphylos 'Emerald Carpet

Fragaria vesca Beach Strawberry Plant From Flats @ 12" o.c.

Planting Notes:

- Circles shown indicate approximate mature size of plant material. Contractor shall be responsible for adequate erosion control measures during
- No plant shall be planted in a drainage swale regardless of position on plan. FINISH GRADING: Till all planter areas to an 8 inch depth. Break up or remove all compacted lumps of soil, rocks larger than 1 inch in diameter, and all deleterious material from planter areas. Finish grade all areas to a smooth, even surface free of abrupt changes in grade. Make minor grading changes as required to insure positive drainage(1% minimum).
- Slopes 3:1 gradient or greater need not be tilled. No plant shall be installed until a fully automatic drip irrigation system, covering all planter areas, is installed, tested and is fully operational.
- 6. PLANTING OF TREES & SHRUBS : Unless otherwise noted, All trees shall be planted per detail: 1
 - All shrubs shall be planted per detail: 2 All planter pits shall receive the following back fill mix:
 - 50% soil of the site
 - 30% nitrogen stabilized redwood shavings 20% Nitrohumus or Gro-power or equal
 - Acid loving plants shall receive peat moss 4. Fertilizer tablets (Agriform 21 gram: 20-10-5) or equal, applied per manufacturer's recommendations.
- Contractor shall guarantee all shrubs, vines & ground covers to live and grow in an acceptable condition for a period of 90 (ninety) days from the date of installation completion. All trees 24" box or larger and field grown specimen trees shall be similarly guaranteed for a period of 1 (one) year from date of installation.
- Upon completion of planting operations, contractor shall apply an approved pre-emergent herbicide (Ronstar or equal) as weed control per manufacturer's specifications. In addition, a min. 3" inch layer of approved mulch shall be installed over the finish grade of all planter areas.
- MAINTENANCE PERIOD: Contractor shall maintain the site for a period of 90 calendar days after acceptance by owner. Maintenance shall include weeding of all shrub and ground cover areas removal of all trash and debris from planter areas and hardscape areas; pruning and trimming of all plant materials required; replacement of all dead or dying plant material & 2 applications of

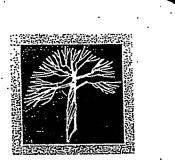

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sheet title

Planting Plan Details & Notes

RESIDENCE 18151 OVERLOOK ROAD LOS GATOS, CA

revisions 1-27-2016 TJS

date 11-16-2015

drawn · sheet no